



EIRGRID BUILDING FLOOR LAYOUT
SCALE 1:200


Eirgrid Building Storm Drainage Network to be into Compound Storm Drainage Network
IPP Building Foul Drainage to Foul Holding Tank

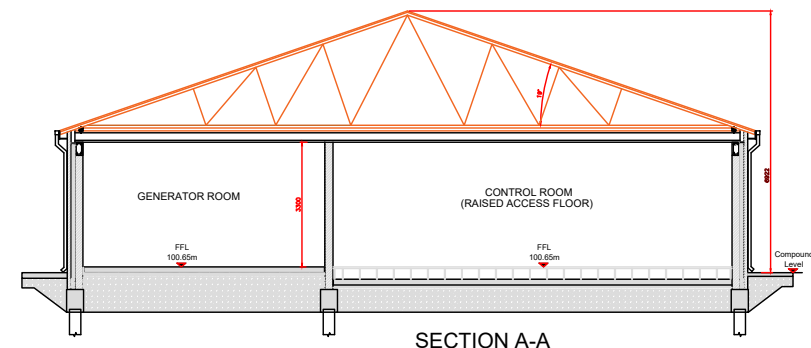


SECTION A-A
SCALE 1:200

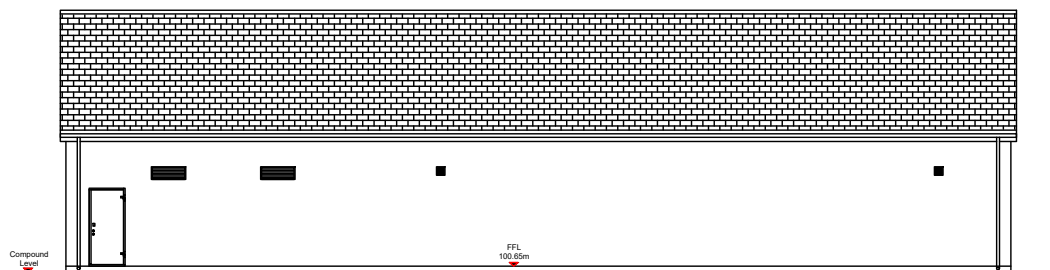


EAST ELEVATION
SCALE 1:200

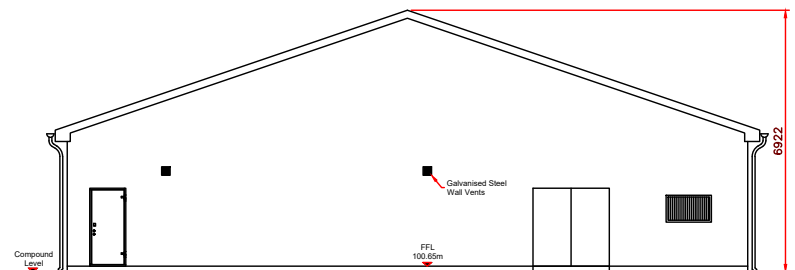

NORTH ELEVATION
SCALE 1:200

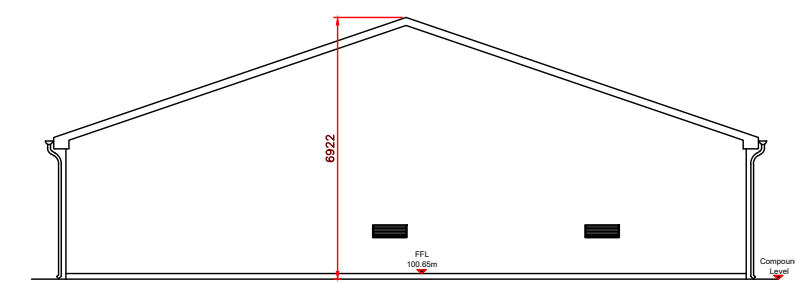

SOUTH ELEVATION
SCALE 1:200

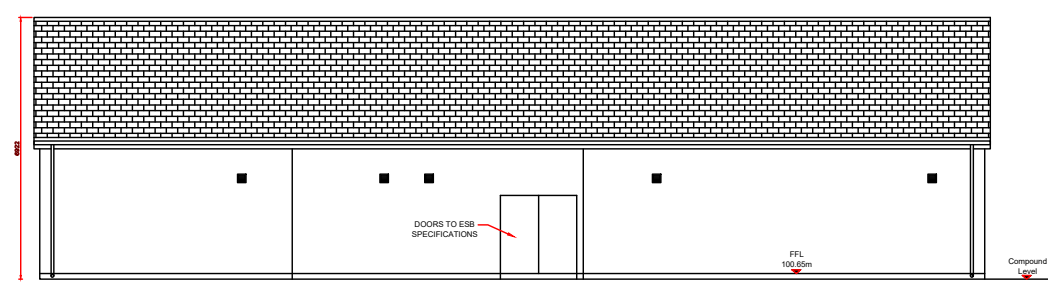

WEST ELEVATION
SCALE 1:200

Legend:

Concrete Footpath (Impermeable)	
100mm Ø uPVC Foul Water Pipe	
150mm Ø uPVC Storm Water Pipe	
Foul Water AJ	
Storm Water AJ	



Date: Rev: Description: Drawn By:

Prepared By:



Galetech Energy Services
Clondorgan, Stradone
Co. Cavan, H12 NV06
info@galetechenergy.com
www.galetechenergy.com

Client: **Drumlins Park Ltd.**







Job Title: **Drumlins Park Wind Farm Substation & Grid Connection**

Drawing Title: **Eirgrid Building Plan and Elevations**

Drawing No.: **DRU001SS_EIAR_GA-0.01** Revision No.: **Rev00**

Scale: **(A3) 1:200** Date: **03/12/2020**

Drawn By: **J.B.** Checked By: **S.C.** Confirmed By: **S.C.**

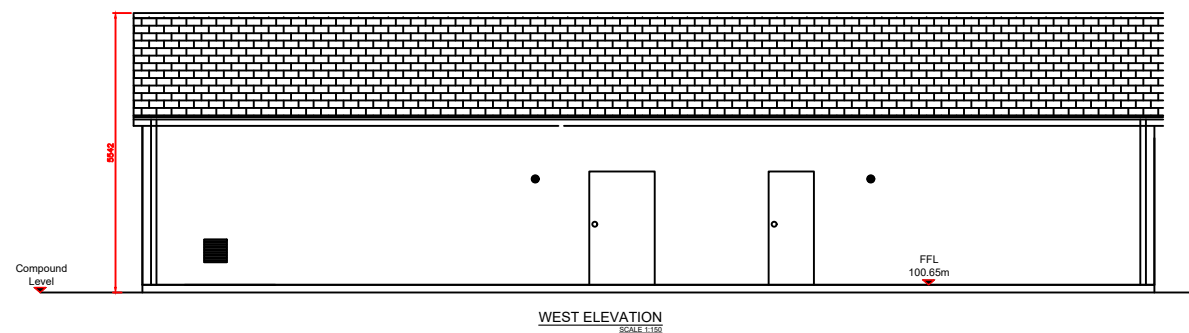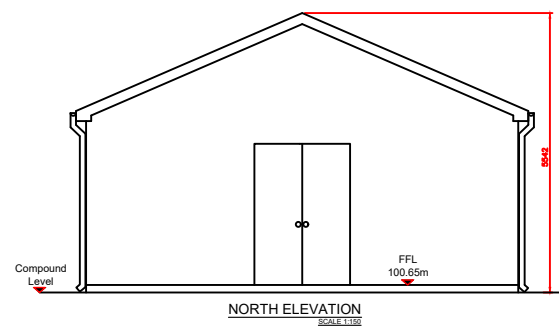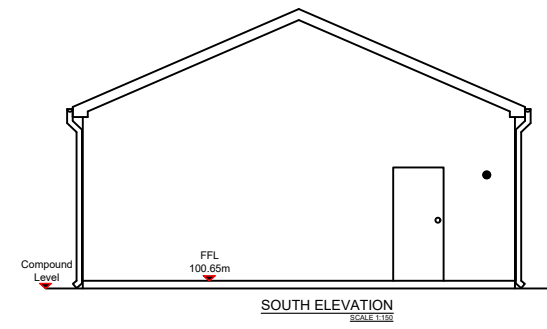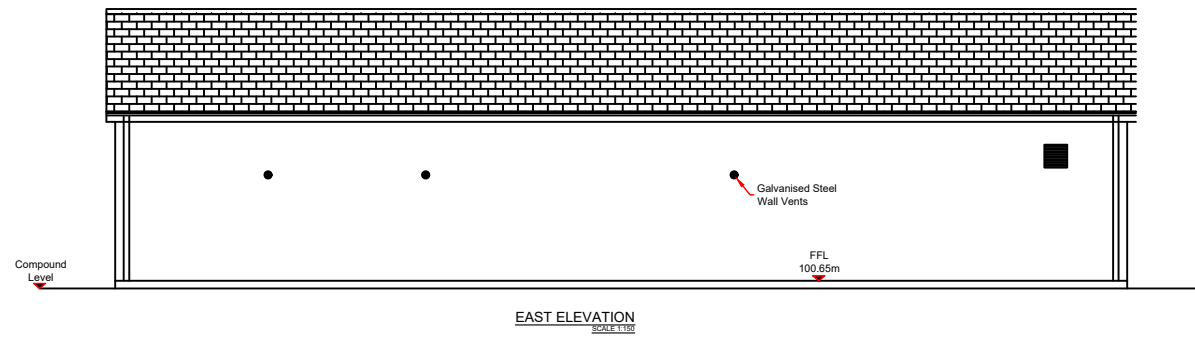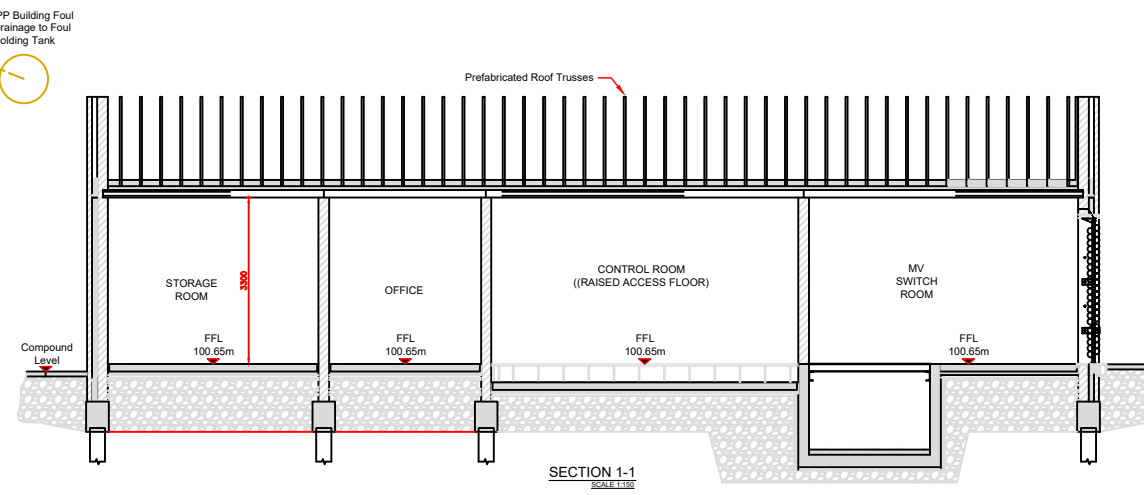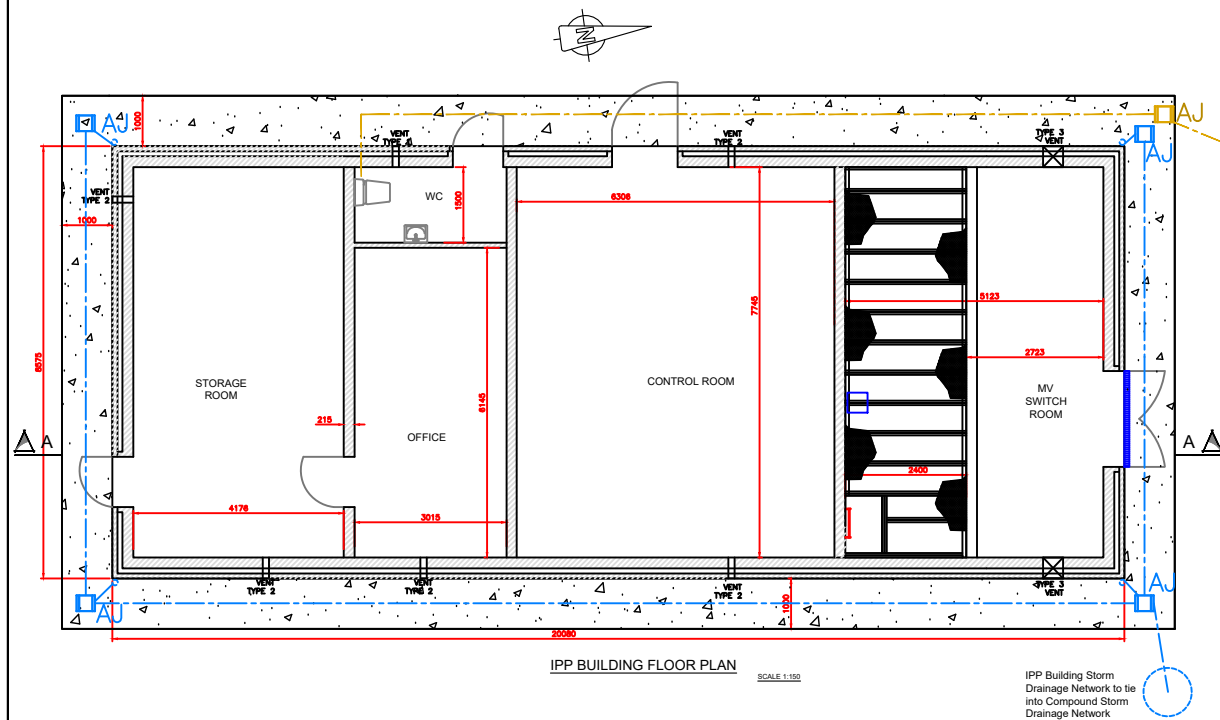

Legend:

Concrete Footpath (Impermeable)	
100mm Ø uPVC Foul Water Pipe	
150mm Ø uPVC Storm Water Pipe	
Foul Water AJ	
Storm Water AJ	

Date:	Rev:	Description:	Drawn By:

Prepared By:



Galetech Energy Services
 Clondargan, Stradone
 Co. Cavan, H12 NV06
 info@galetechenergy.com
 www.galetechenergy.com

Client: **Drumlins Park Ltd.**

Job Title: **Drumlins Park Wind Farm Substation & Grid Connection**

Drawing Title: **IPP Building Plan and Elevations**

Drawing No.: DRU001SS_EIAR_GA-0.02	Revision No.: Rev00
Scale: (A3) 1:150	Date: 03/12/2020
Drawn By: J.B.	Checked By: S.C.
	Confirmed By: S.C.