



- NOTES:
- DO NOT SCALE. USE FIGURED DIMENSIONS ONLY.
 - THIS DRAWING IS TO BE READ IN CONJUNCTION WITH ALL OTHER RELEVANT ARCHITECTURAL AND ENGINEERING DRAWINGS.

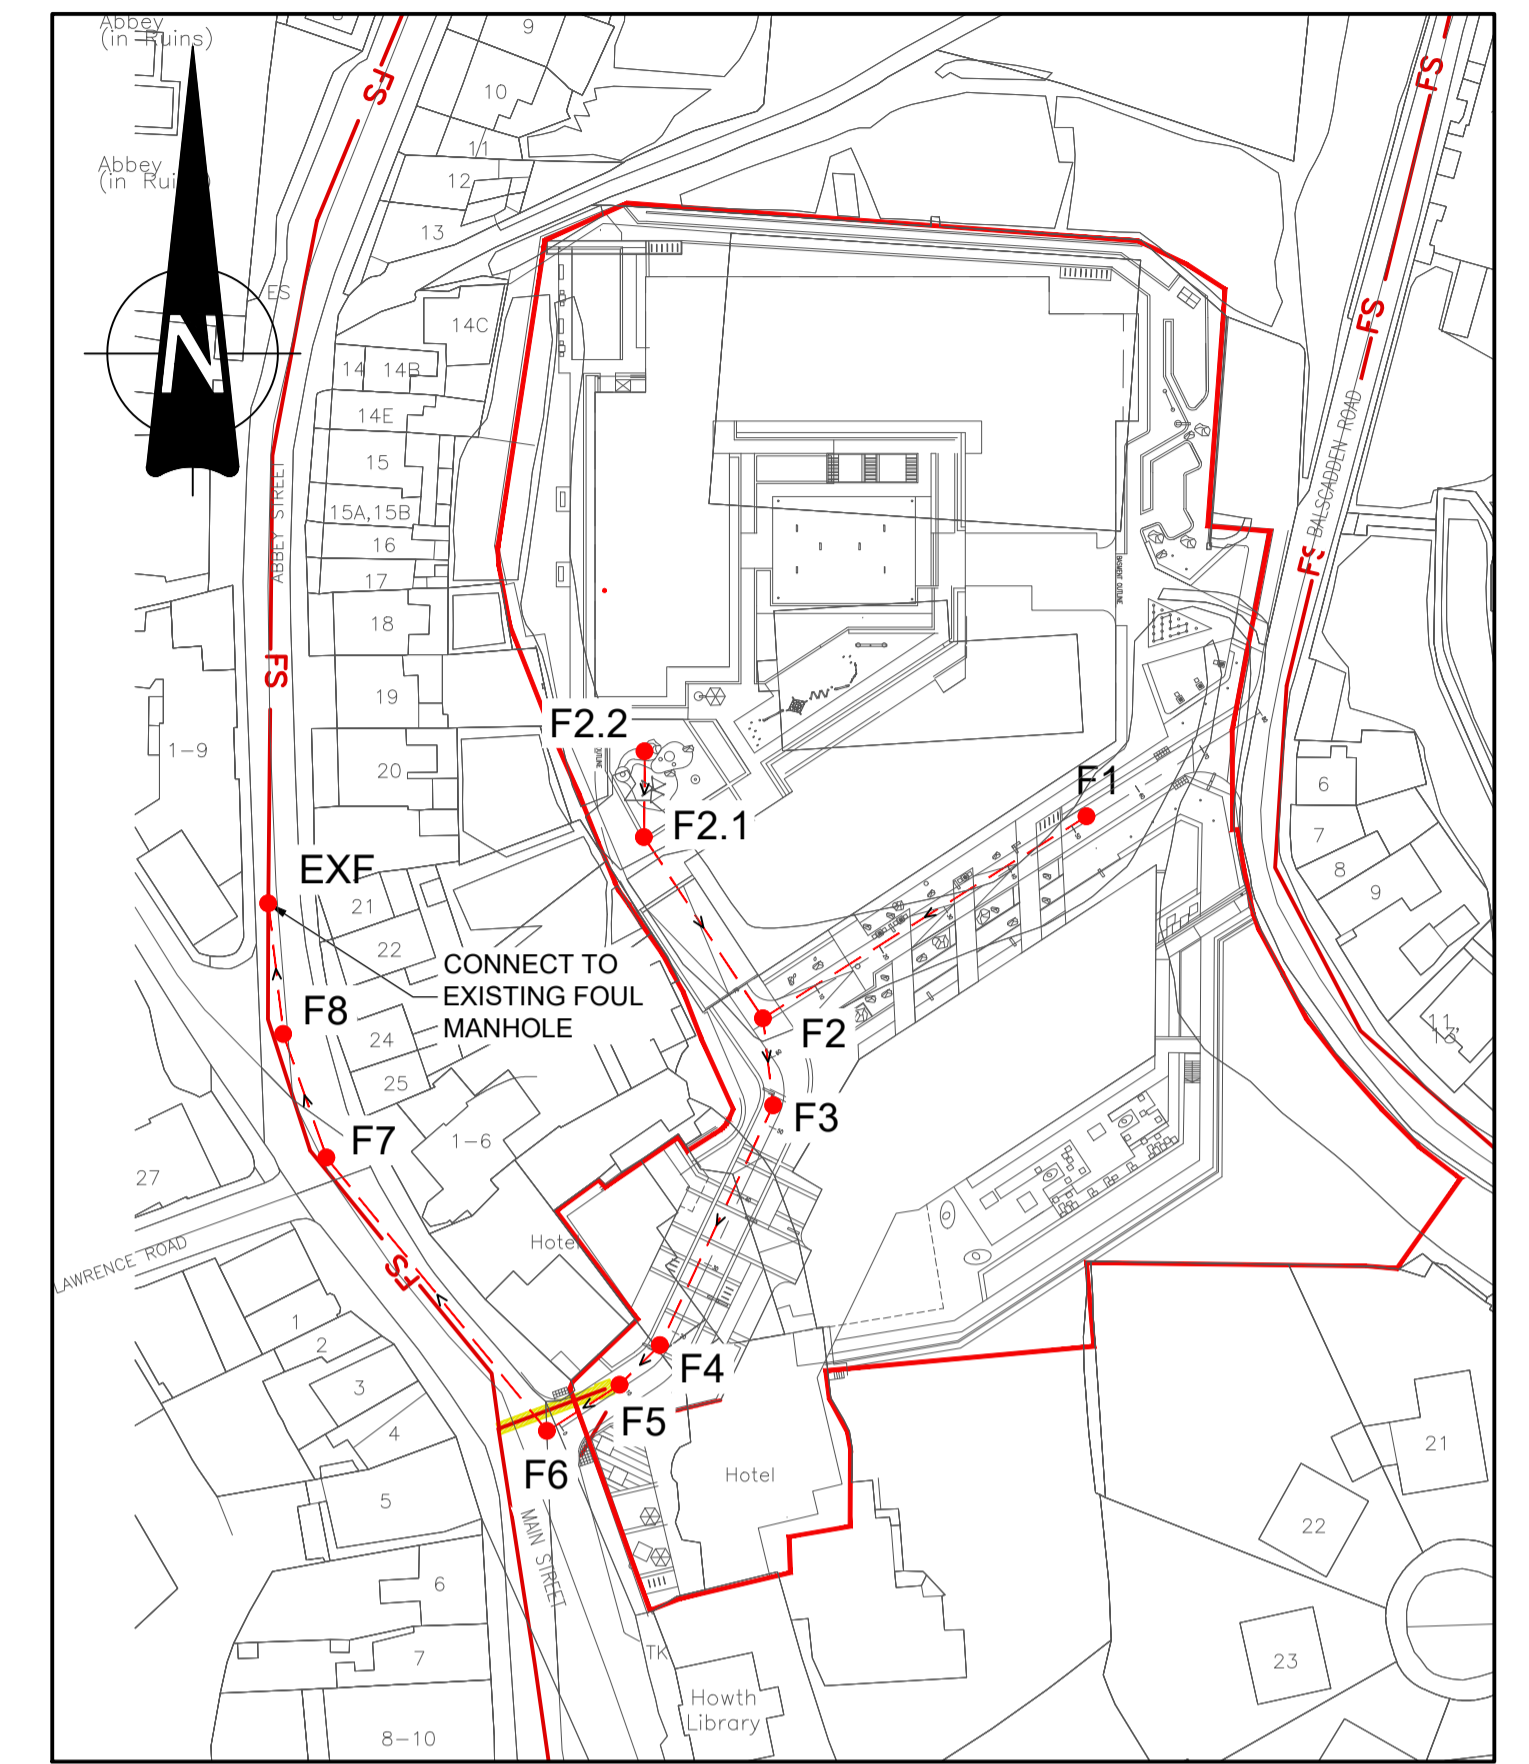


FOUL DRAINAGE SCHEMATIC
SCALE 1:1000

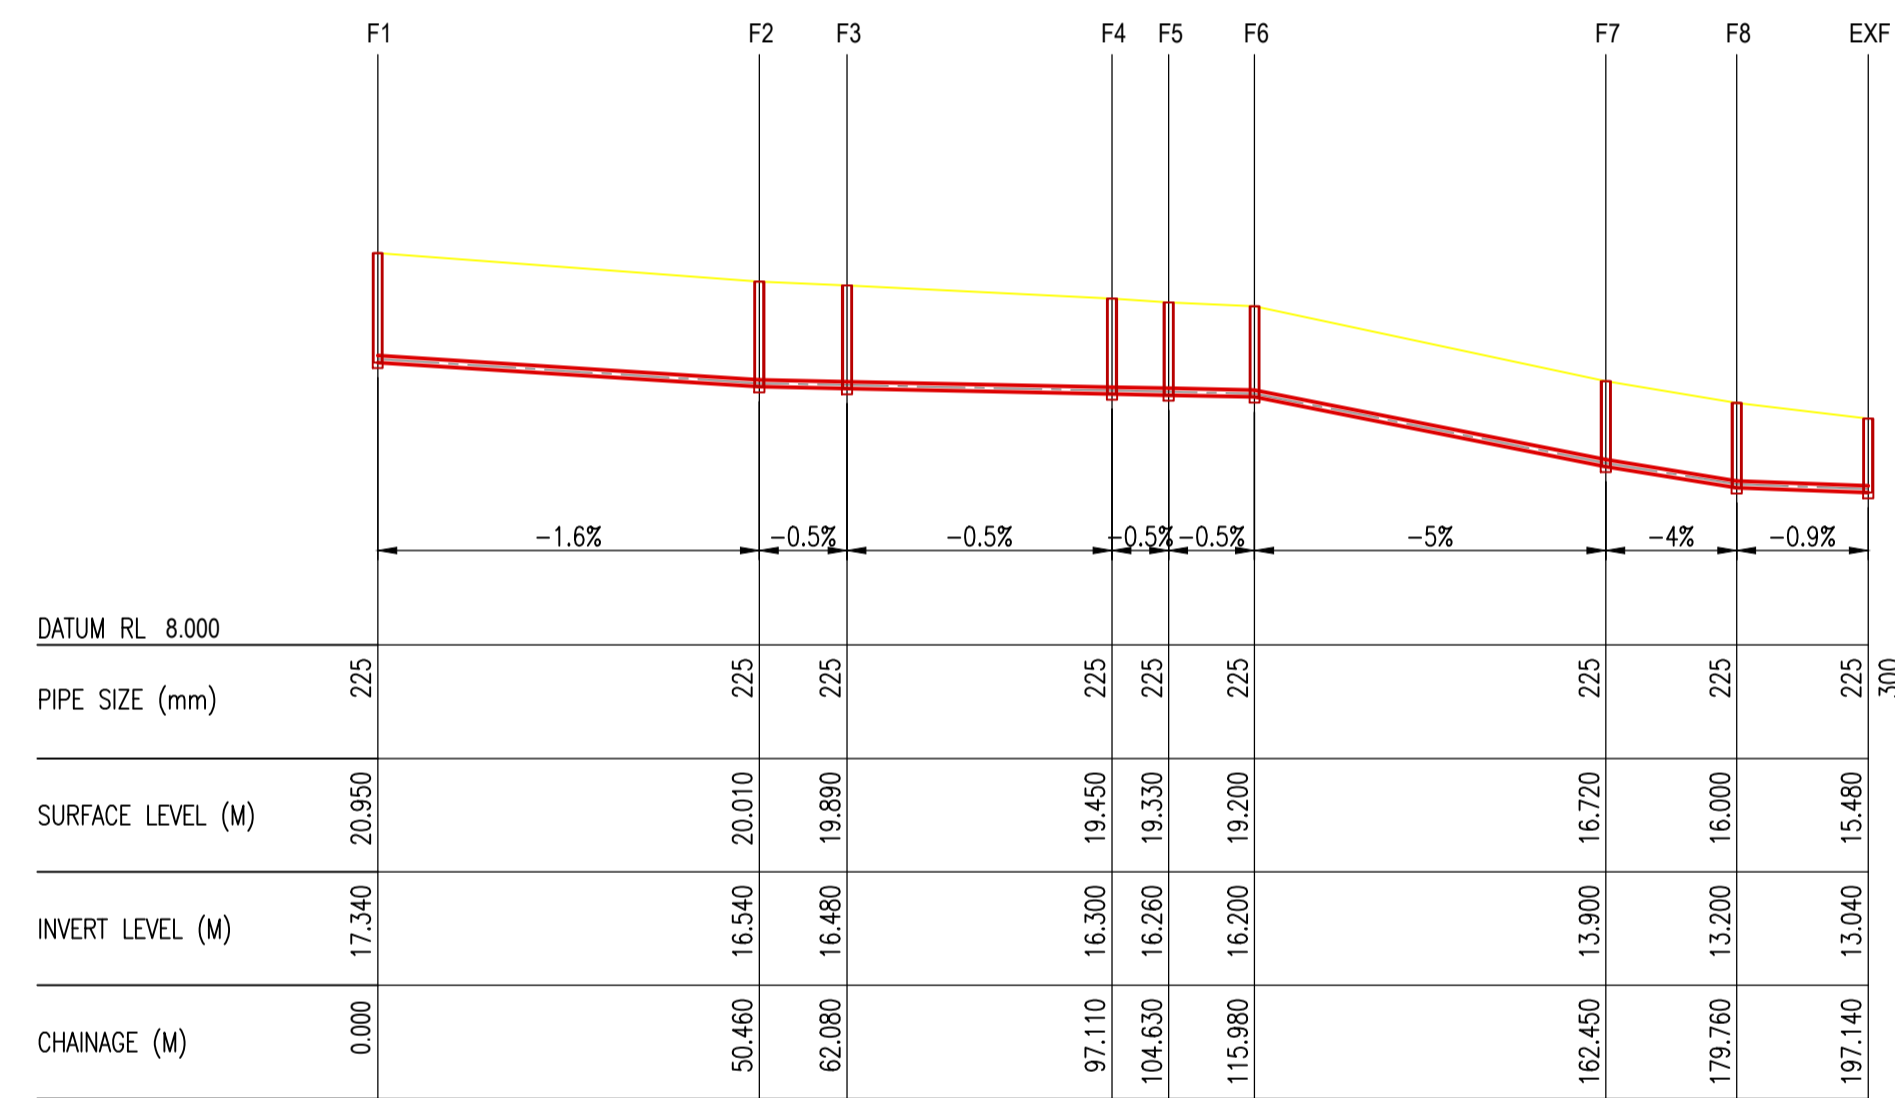

LONGITUDINAL SECTION FROM MANHOLE F1 TO EXF

SCALES - 1:1000 H
1:250 V

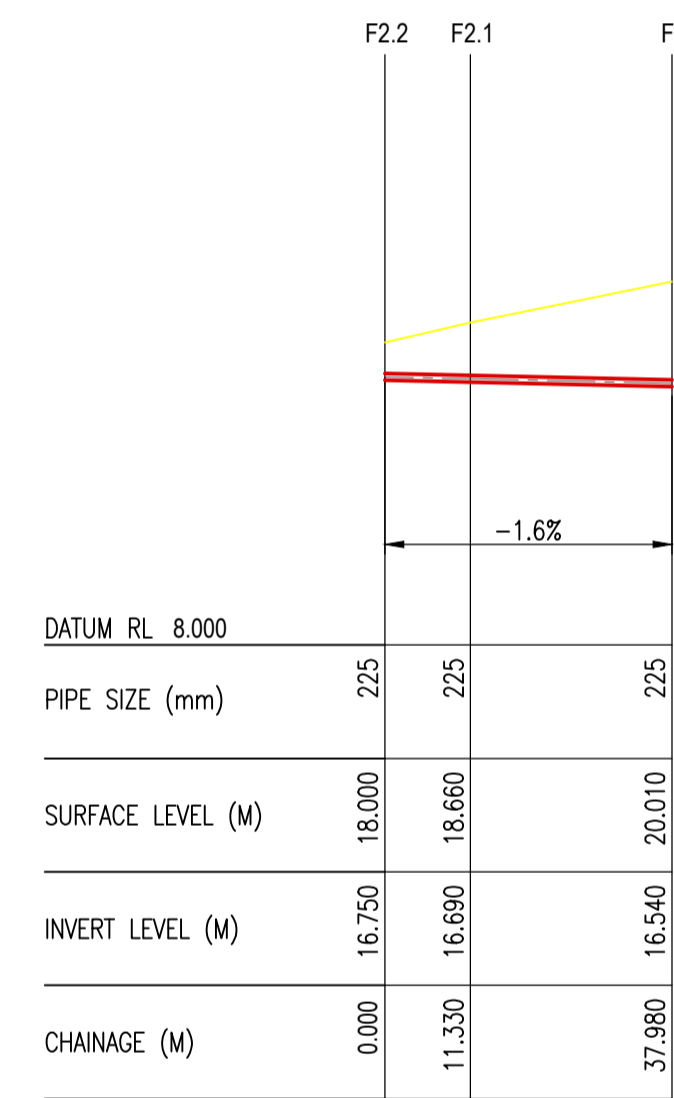


LONGITUDINAL SECTION FROM MANHOLE F2.2 TO F2

SCALES - 1:1000 H
1:250 V

LEGEND

- INDICATES PROPOSED GROUND LEVEL
- INDICATES PROPOSED uPVC SN8 FOUL PIPE

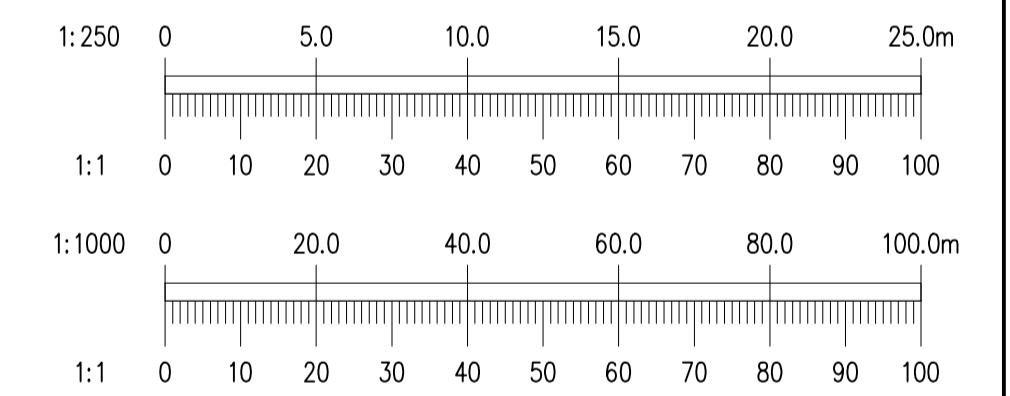

REV.	DATE	AMENDMENT	DRN	APPD

STATUS **FOR PLANNING
NOT FOR CONSTRUCTION**

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ARCHITECT **PLUS ARCHITECTURE**
PROJECT
BALSCADDEN DEVELOPMENT, HOWTH, CO. DUBLIN

TITLE
**PROPOSED FOUL DRAINAGE
LONGITUDINAL SECTIONS**

DRAWN	DESIGNED	APPROVED	DATE
PJD	SDN	MD	FEB '22
SCALE	JOB NO.	DRG. NO.	REVISION
1:1000H, 1:250V @ A1	21-032	P029	

NOTE:
REFER TO DRAWING 21-032, P20
FOR DRAINAGE LAYOUT

NOTE:
WHERE PIPE COVER IS LESS THAN 1.2m IN
ROAD PIPE TO BE ENCASED IN CONCRETE SURROUND

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