



Notes

Do not scale from this drawing.
 Use figured dimensions only.
 All errors and omissions to be reported to the Architect.
 This drawing is to be read in conjunction with relevant consultant's drawings.
 All dimensions are in millimetres and all levels are in meters to match Datums unless otherwise noted.


This drawing is for planning purposes only and not for construction.
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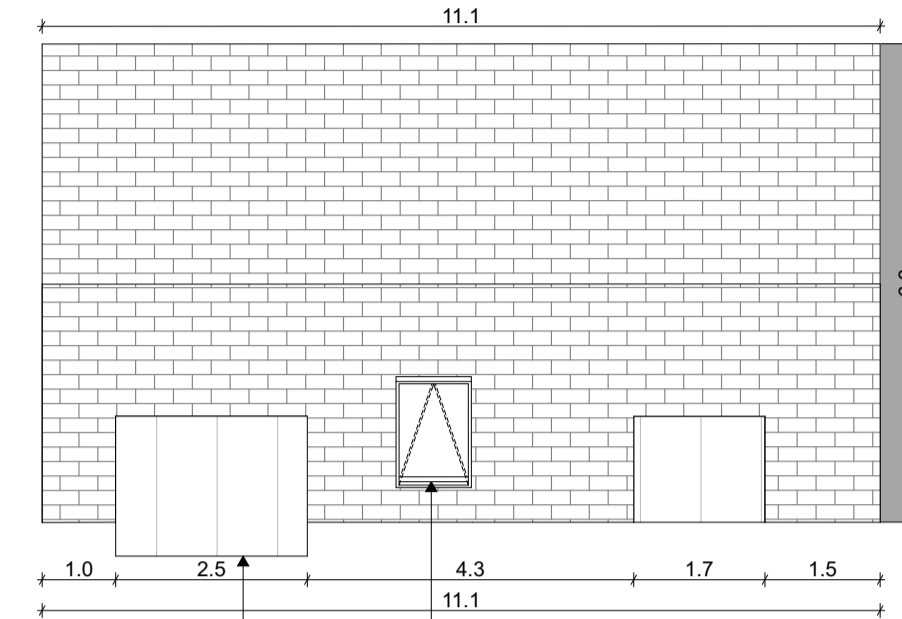
Ground Floor Plan
 SCALE 1:100
 GFA: 60.0 m²

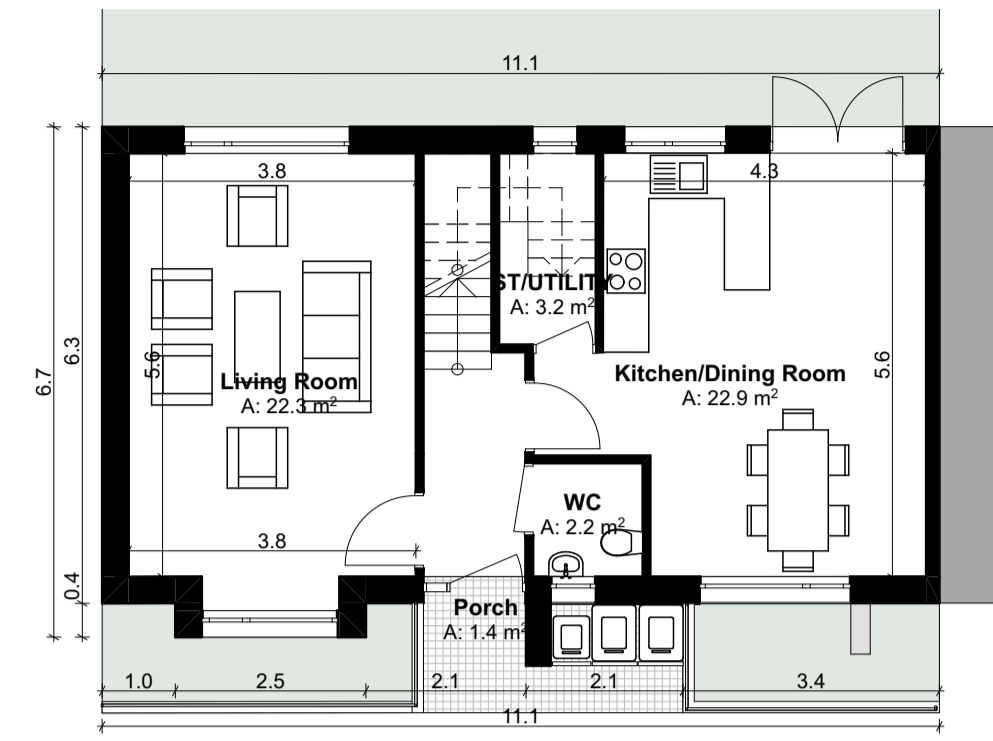

First Floor Plan
 SCALE 1:100
 GFA: 60.0 m²

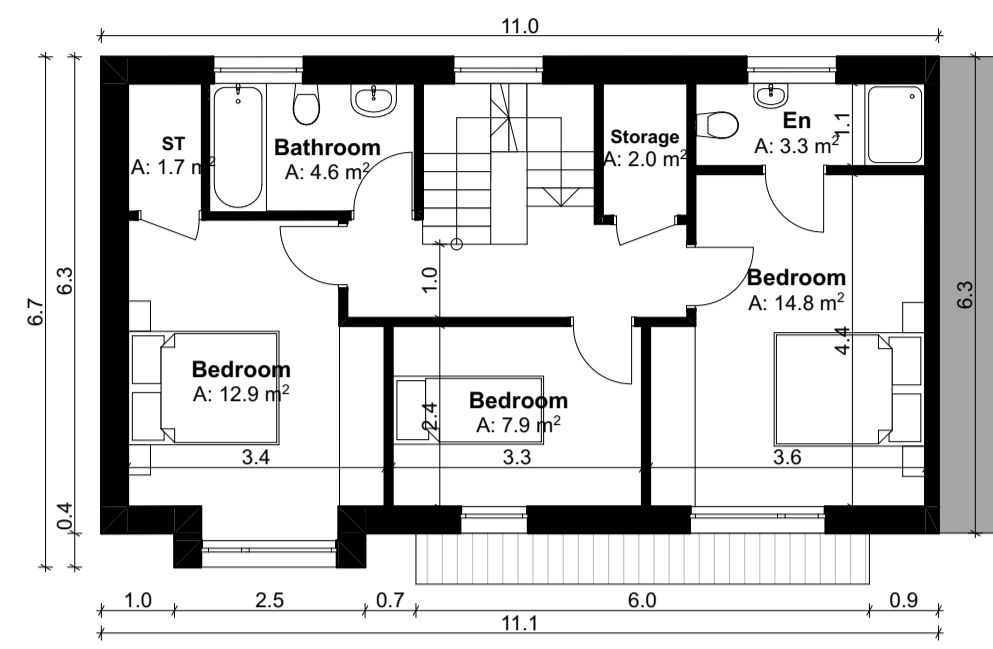


Future Attic Conversion Layout
 SCALE 1:100

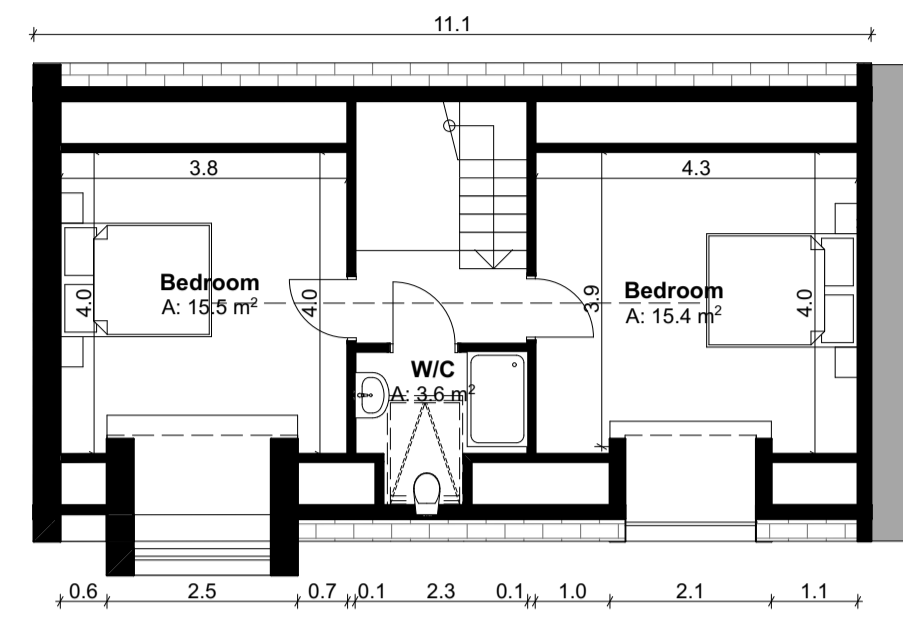


Roof Plan
 SCALE 1:100
 ZINC DORMERS PROVIDED FOR FUTURE ATTIC CONVERSION
 FRONT ROOFLIGHT PROVIDED FOR FUTURE ATTIC CONVERSION


NOTES ON FINISHES:	
ROOF:	TO BE FINISHED IN SLATE OR CONCRETE ROOF TILES IN SELECTED COLOUR OR SIMILAR APPROVED
DORMER:	DORMER WINDOWS TO BE FINISHED IN METAL ZINC CLADDING IN SELECTED COLOUR OR SIMILAR APPROVED
WALLS:	SELECTED CLAY BRICKWORK WHERE INDICATED OTHERWISE SELECTED SELF-COLOURED RENDER
JOINERY:	ALL WINDOWS AND DOORS, FRAMES AND LEAFS TO BE ALUMINIUM POWDER COATED TO APPROVED COLOUR OR UPVC OR PAINTED TIMBER TO APPROVED COLOUR. OBSCURE GLAZING WHERE INDICATED TO SENSITIVE WINDOWS.
RAINWATER GOODS:	GUTTERS, DOWNPIPES AND FIXINGS TO BE uPVC OR ALUMINIUM POWDER COATED TO SELECTED COLOUR TO MATCH ROOF SLATES.

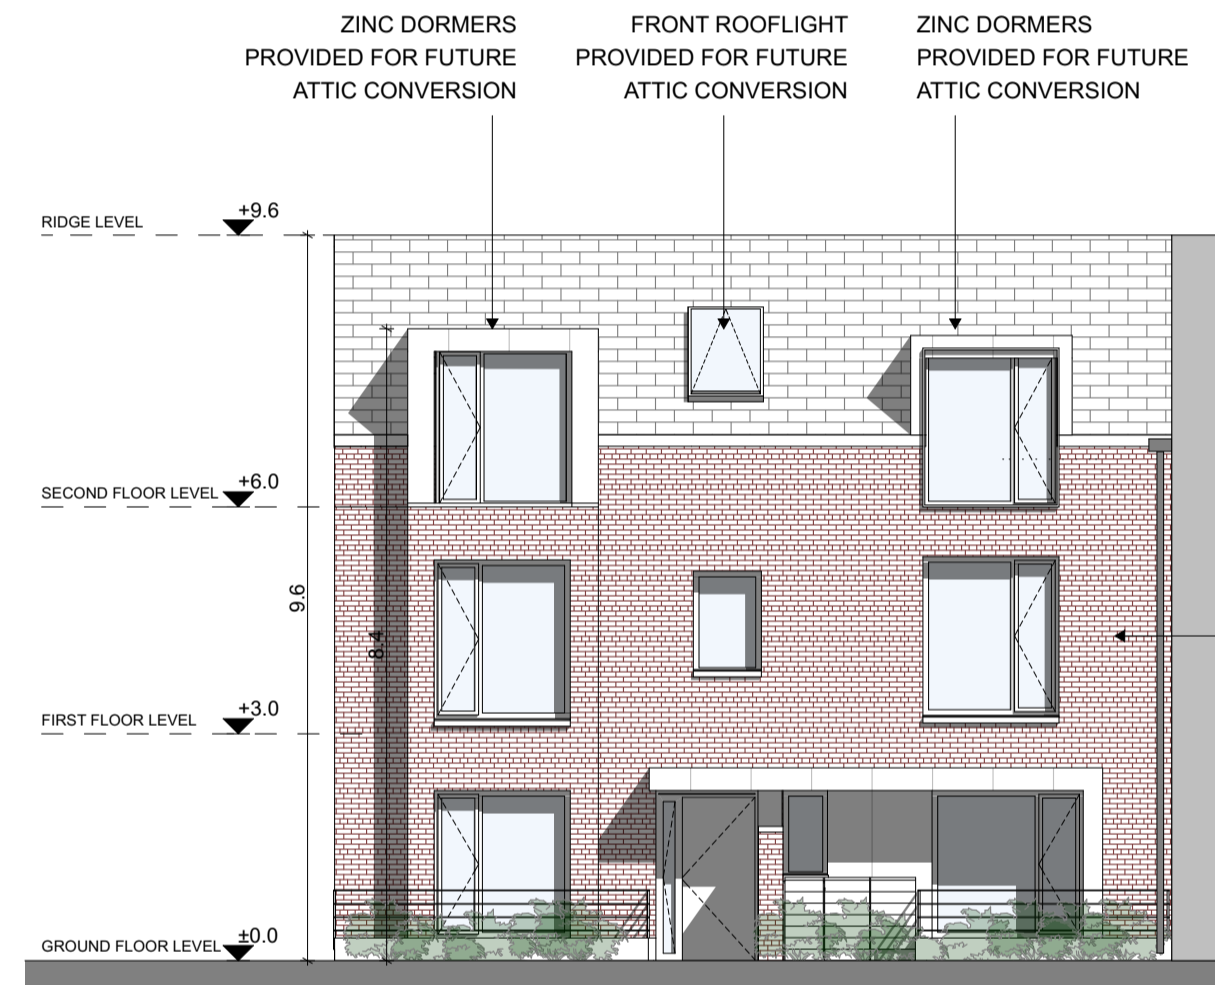

Front Elevation
 SCALE 1:100

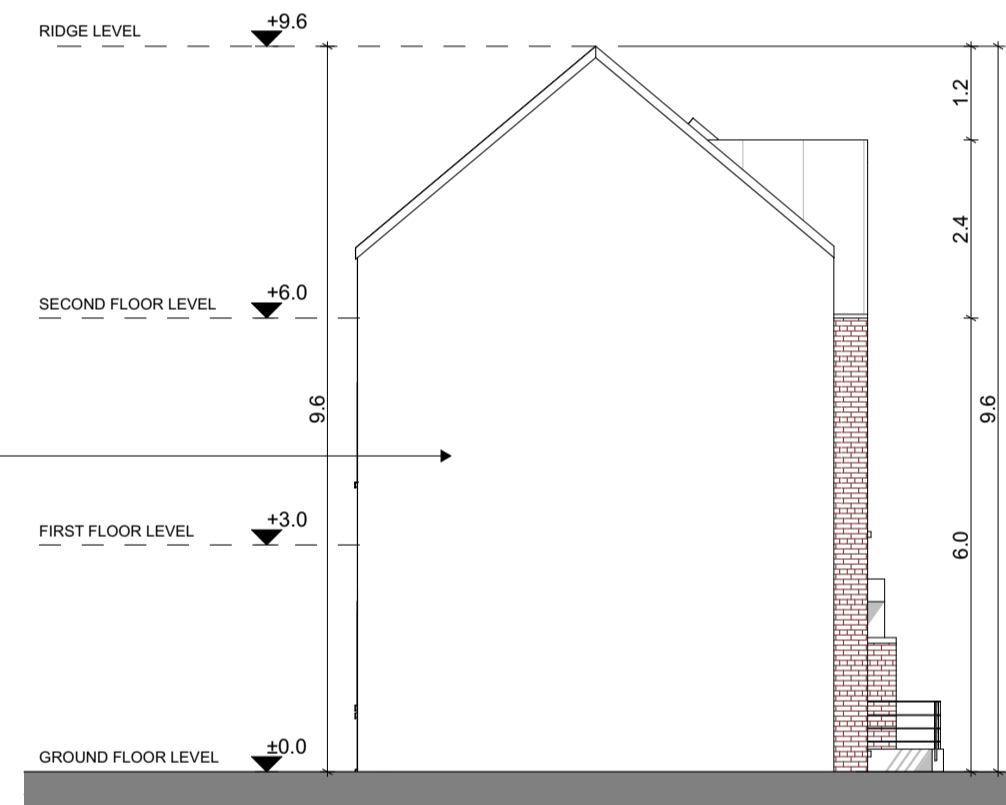

Side Elevation
 SCALE 1:100

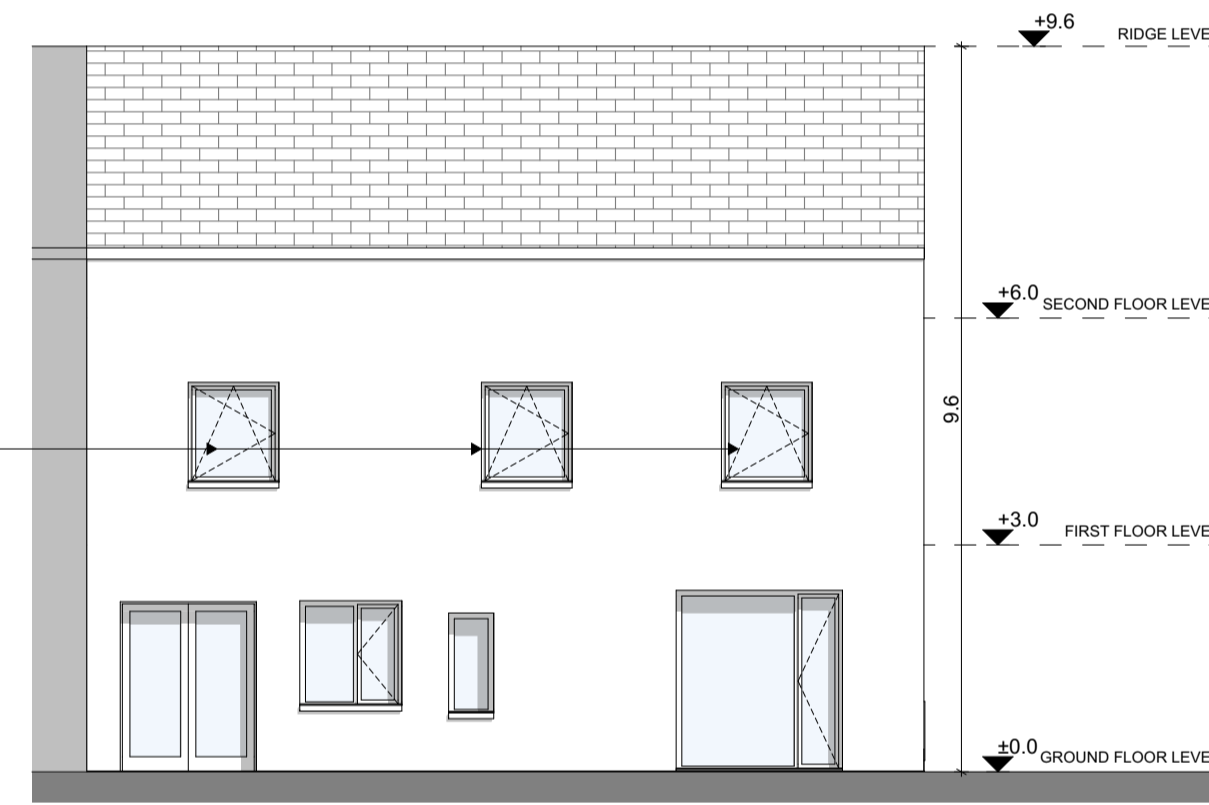


Rear Elevation
 SCALE 1:100

House Type - E-O - Gross Internal Area		
Area Type	Proposed Area	DoHPCLG Area Min.
Ground Floor	60.0 m ²	
First Floor	60.0 m ²	
Grand Total	120.0 m ²	92.0 m ²

House Type - E-O - Space Provision & Room Sizes		
Area Type	Proposed Area	DoHPCLG Area Min.
Aggregate Bedroom Area	35.6 m ²	32 m ²
Aggregate Living Area	45.2 m ²	34 m ²
Main Living Area	22.3 m ²	13.0 m ²

House Type - E-O - Storage Provision		
Area Type	Proposed Area	DoHPCLG Area Min.
Storage	6.9 m ²	5.0 m ²

Refer to Site Plan for:
 - Finished floor levels to survey datum
 - Orientation
 - Handing of type for each unit

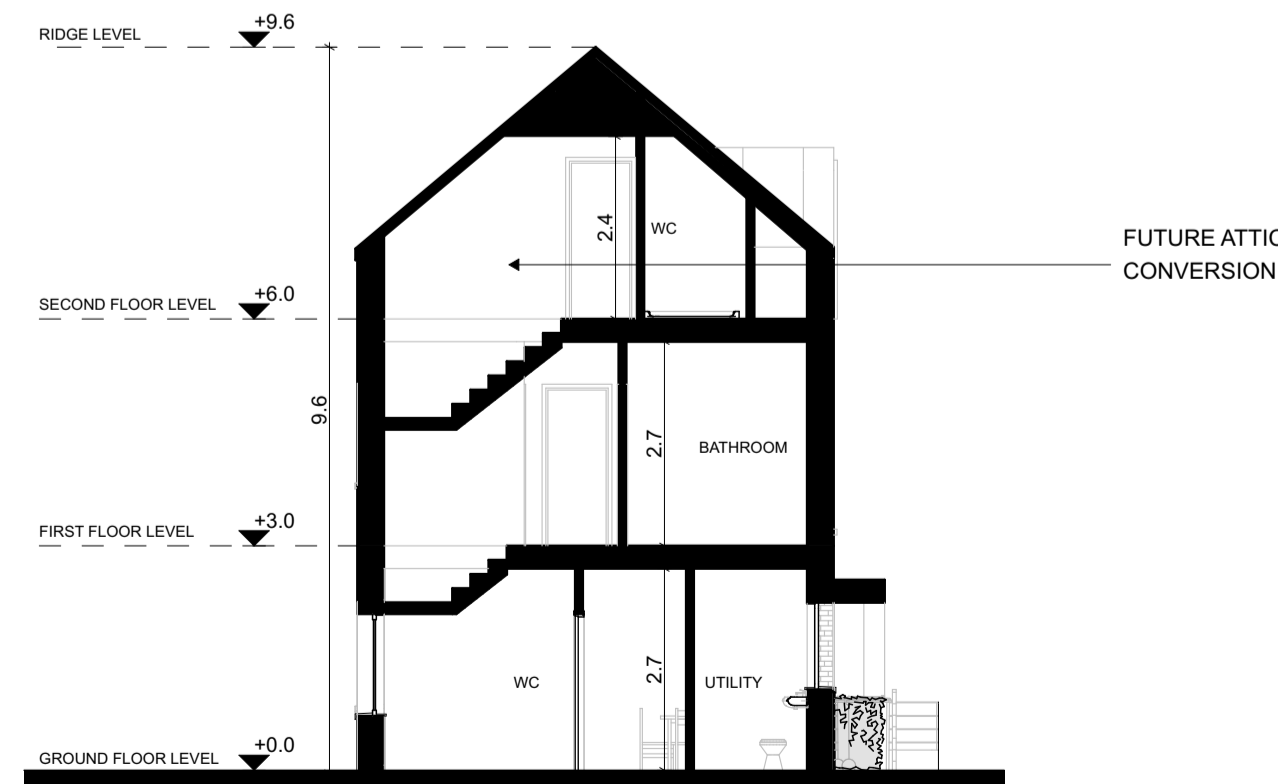

Typical Section
 SCALE 1:100

FOR ORIENTATION AND HANDING
 PLEASE REFER TO SITE PLAN



E-O

(3 BED MID/END/SEMI UNIT)

TGFA: 120.0 m²

RIAI	Planning Application	DAVEY + SMITH ARCHITECTS
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DAVEY+SMITH ARCHITECTS 13 SEAPORT BUILDING, 44/45 CLONTARF ROAD, CLONTARF, DUBLIN 3 PH: 01 2447638 EMAIL: info@davey-smith.com WEB: www.davey-smith.com	Scale: 1:100
Layout ID: D2101 - UT08	Job No: D2101
Project: Ashbourne SHD	Series: Planning
Drawing Name: Type E-O - Proposed Floor Plans, Elevations and Section	Date: 31/08/2022
	Status: Planning

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