


**PALISADE FENCING  
GENERAL ARRANGEMENT**  
SCALE 1:500

**Note:**  
For sections and further details refer to Drawing No: MT-006-004  
For Location of Woodland Substation please refer to Drg. No: MT-006-001 & MT-006-002

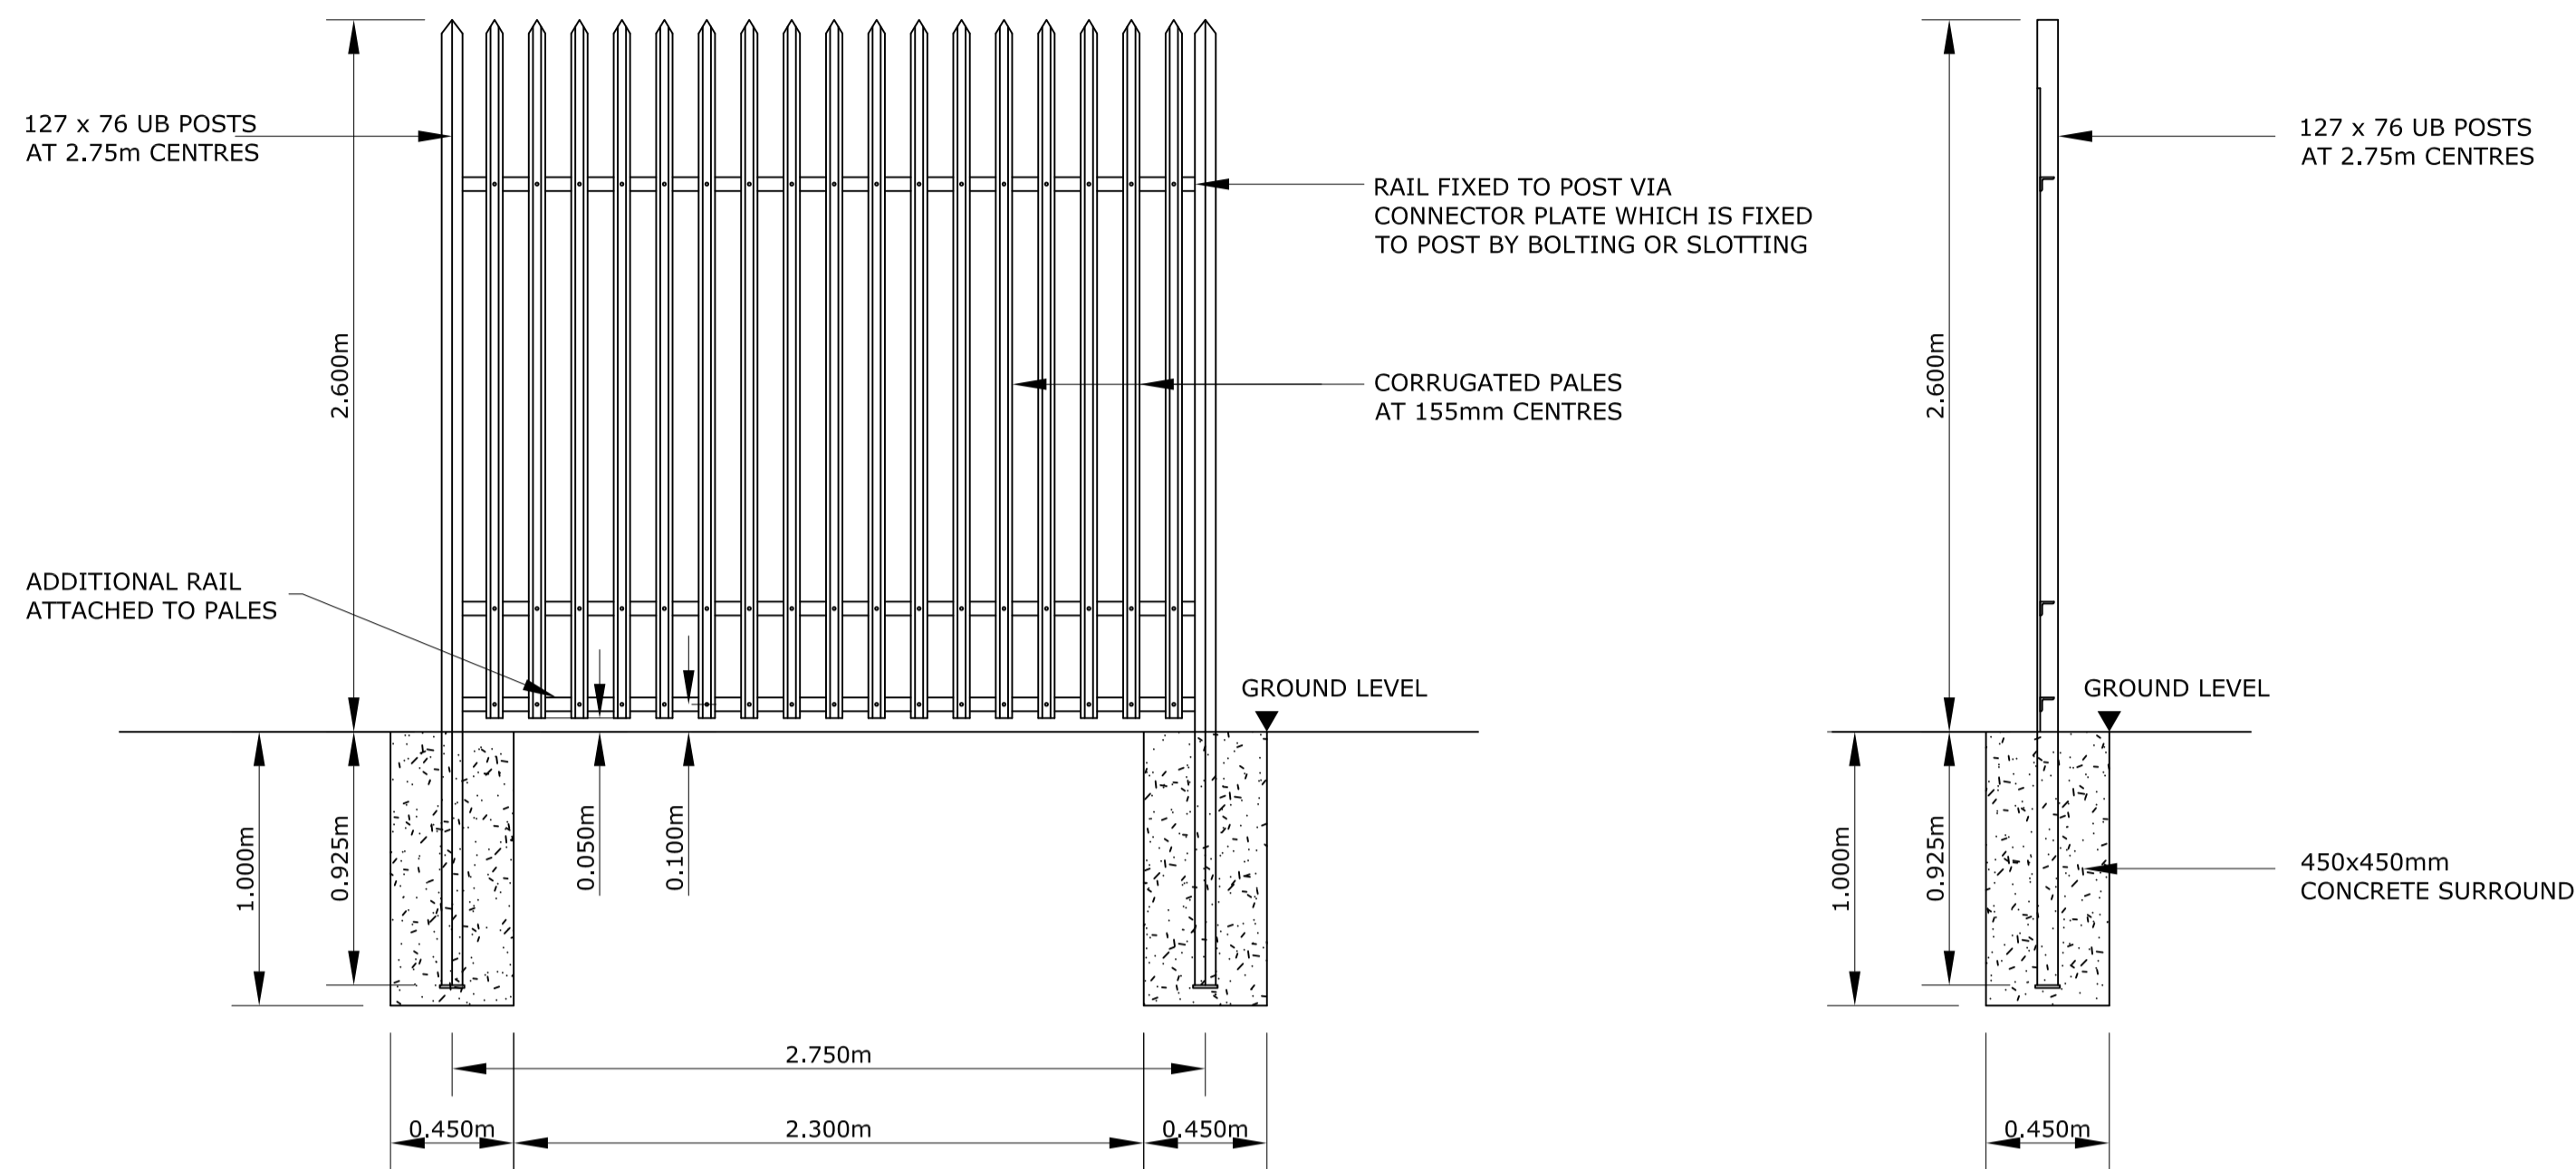


**DETAIL A  
TYPICAL ARRANGEMENT OF STEEL PALISADE FENCE**  
SCALE 1:25

- Legend:**
- Woodland Substation Planning Area
  - X
 Existing Equipment
  - X
 Proposed Equipment
  - Existing Fencing
  - Existing Fencing to be removed
  - Proposed New Fencing


DRAFT

- NOTES:**
- FIGURED DIMENSIONS ONLY TO BE TAKEN FROM THIS DRAWING.
  - ALL LEVELS SHOWN RELATE TO ORDNANCE SURVEY DATUM AT MALIN HEAD

Rev	Date	Description	By	Chkd.
A	Jan.'14	PLANNING ISSUE	MN	DG

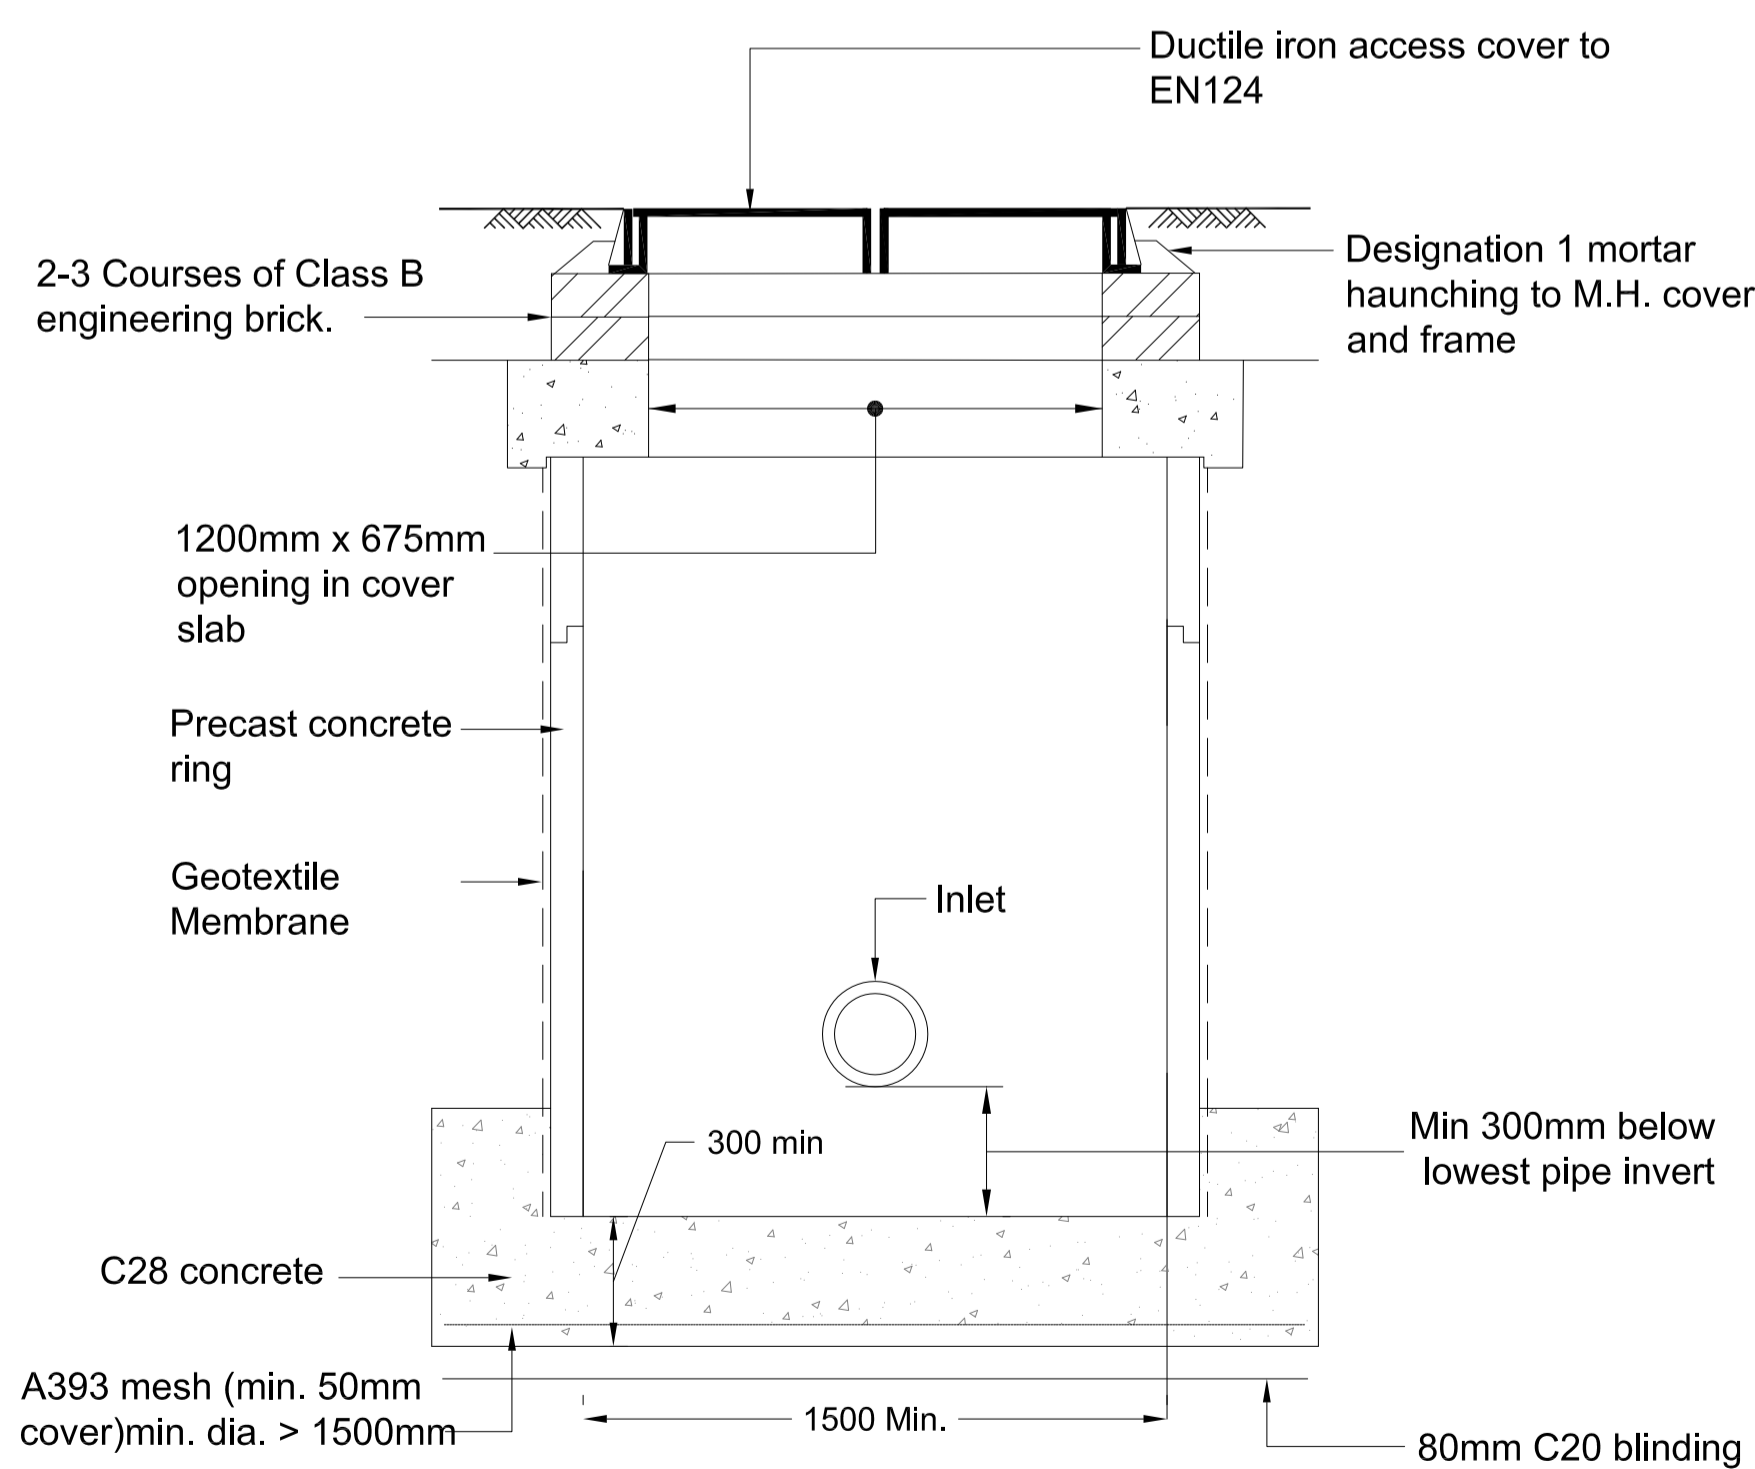

**TYPICAL PRECAST MANHOLE DETAIL**  
SCALE 1:20

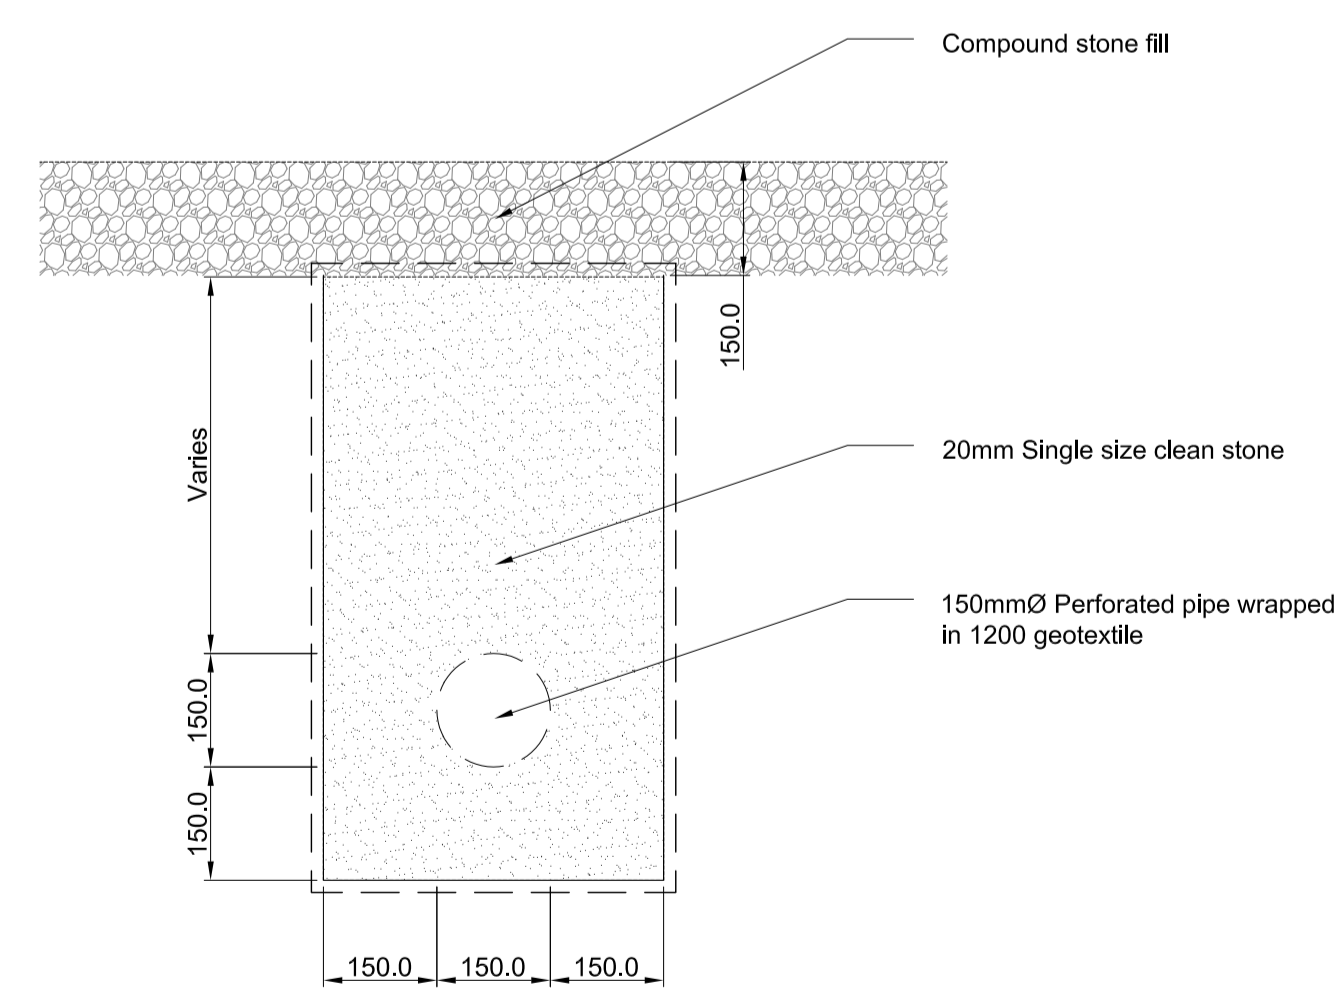

**TYPICAL LAND DRAIN DETAIL**  
Scale 1:10

**Note:**  
For drainage layout refer to Drawing No: MT-006-005



Client: **EIRGRID**  
Project: **NORTH - SOUTH 400 KV INTERCONNECTION DEVELOPMENT**

Title: **MEATH STUDY AREA (MSA) WOODLAND 400 KV SUBSTATION TYPICAL DETAILS**

Scale @ A1: **AS SHOWN**  
Prepared by: **M. Nolan** Checked: **D. Grehan** Date: **January 2014**  
Project Director: **D. Grehan**  
Planning Dwg. Ref: **MT-006-006**



Drawing No.: **6244-2057** Revision: **A**