
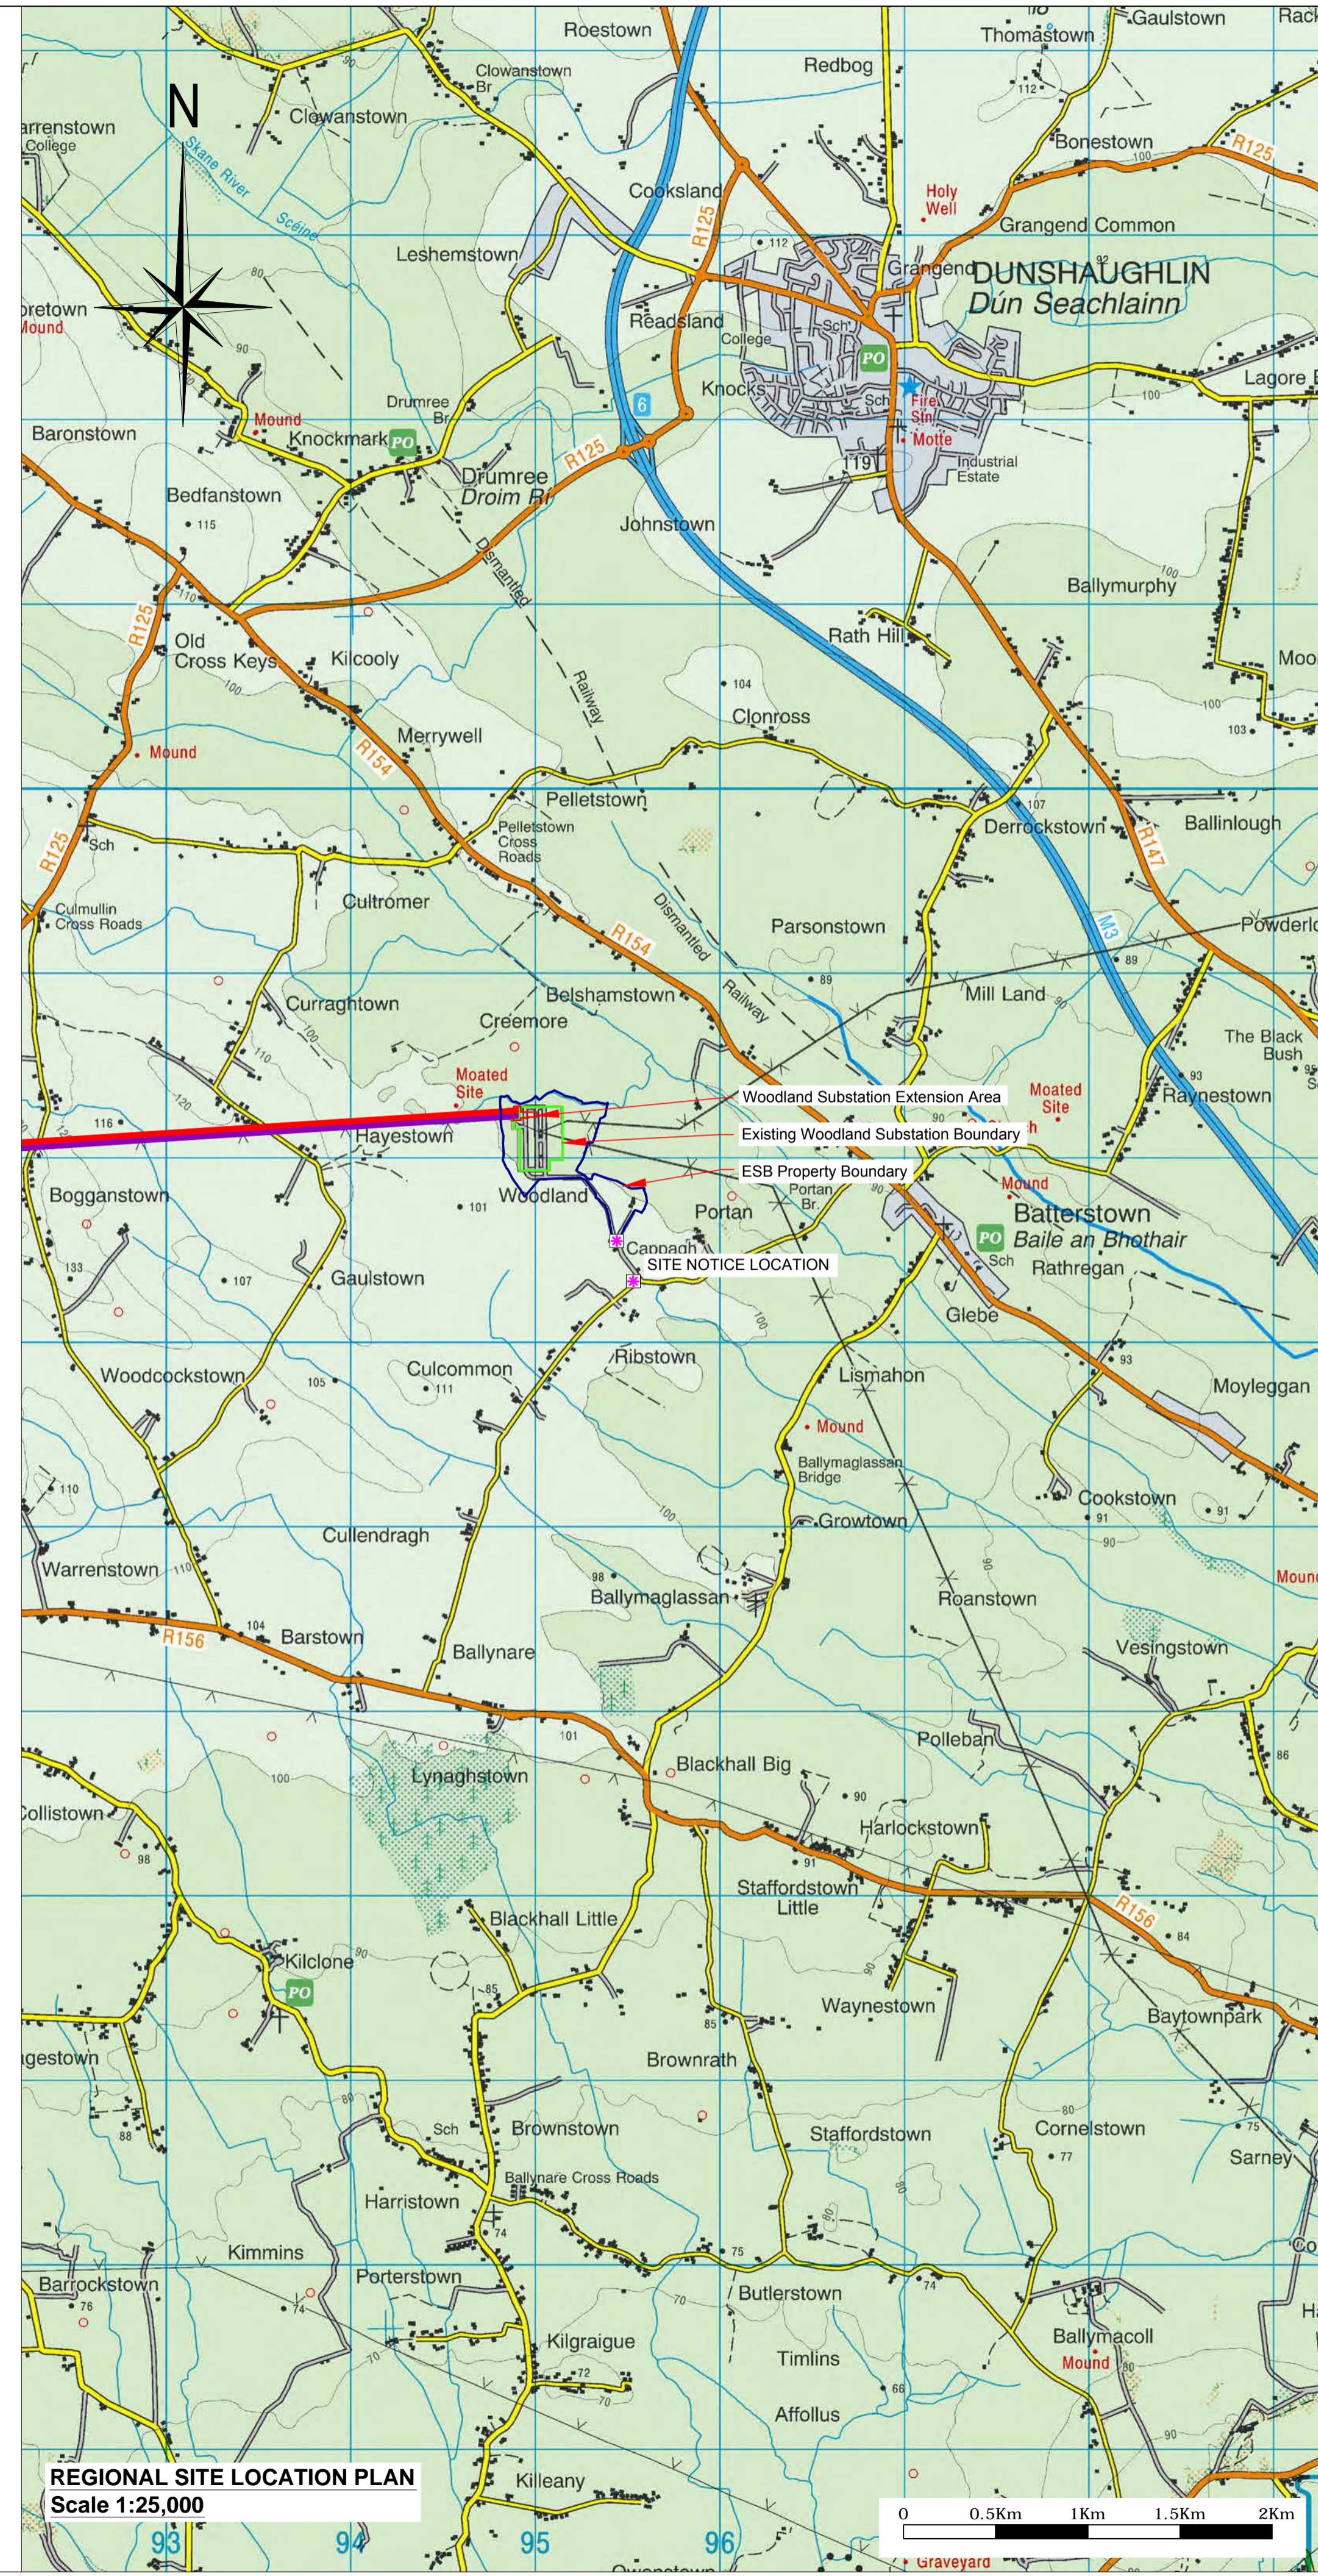


OVERALL SITE PLAN
Scale 1:1,000

Note:
For site layout plan @ 1:500
refer to Planning Drawing Reference: MT-006-003.

For sections and further details
refer to Planning Drawing Reference: MT-006-004.

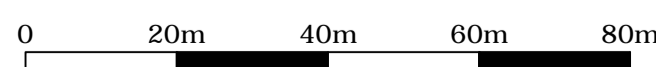

REGIONAL SITE LOCATION PLAN
Scale 1:25,000



- LEGEND:**
- Woodland Substation Planning Area
 - Existing Woodland Substation Boundary
 - ESB Property Boundary
 - Existing 400 kV Double Circuit Line
 - Existing Equipment
 - Proposed Equipment
 - ✱ Site Notice Location

DRAFT

- NOTES:**
1. FIGURED DIMENSIONS ONLY TO BE TAKEN FROM THIS DRAWING.
 2. ALL LEVELS SHOWN RELATE TO ORDNANCE SURVEY DATUM AT MALIN HEAD
 3. OS DISCOVERY SHEET NO: 2824

Ordnance Survey Ireland Licence number EN 0061514.
© Ordnance Survey Ireland/Government of Ireland

Rev	Date	Description	By	Chkd.
A	Jan. '14	PLANNING ISSUE	MN	DG

Client:

Project:
NORTH - SOUTH 400 kV INTERCONNECTION DEVELOPMENT

Title:
MEATH STUDY AREA (MSA) WOODLAND 400 kV SUBSTATION OVERALL SITE LAYOUT PLAN

Scale @ A1: **AS SHOWN**

Prepared by:	Checked:	Date:
M. Nolan	D. Grehan	January 2014

Project Director: D. Grehan
Planning Dwg. Ref: MT-006-002

TOBIN
Patrick J. Tobin & Co. Ltd.
TOBIN Consulting Engineers,
Block 10-4, Blanchardstown Corporate Park,
Dublin 15, Ireland.
tel: +353-(0)1-8030406
fax: +353-(0)1-8030409
e-mail: dublin@tobin.ie
www.tobin.ie

TOBIN Consulting Engineers will not be liable for any use of this document for any purpose other than that for which it was originally prepared and provided. Except where specifically stated otherwise, all rights are reserved. No part of this document may be reproduced, stored in a retrieval system, or transmitted in any form and this document shall not be relied upon by any third party for any purpose.

Drawing No.: **6244-2053** Revision: **A**