


**PALISADE FENCING
GENERAL ARRANGEMENT**
SCALE 1:500

Note:
For sections and further details refer to Drawing No: MT-006-004
For Location of Woodland Substation please refer to Drg. No: MT-006-001 & MT-006-002

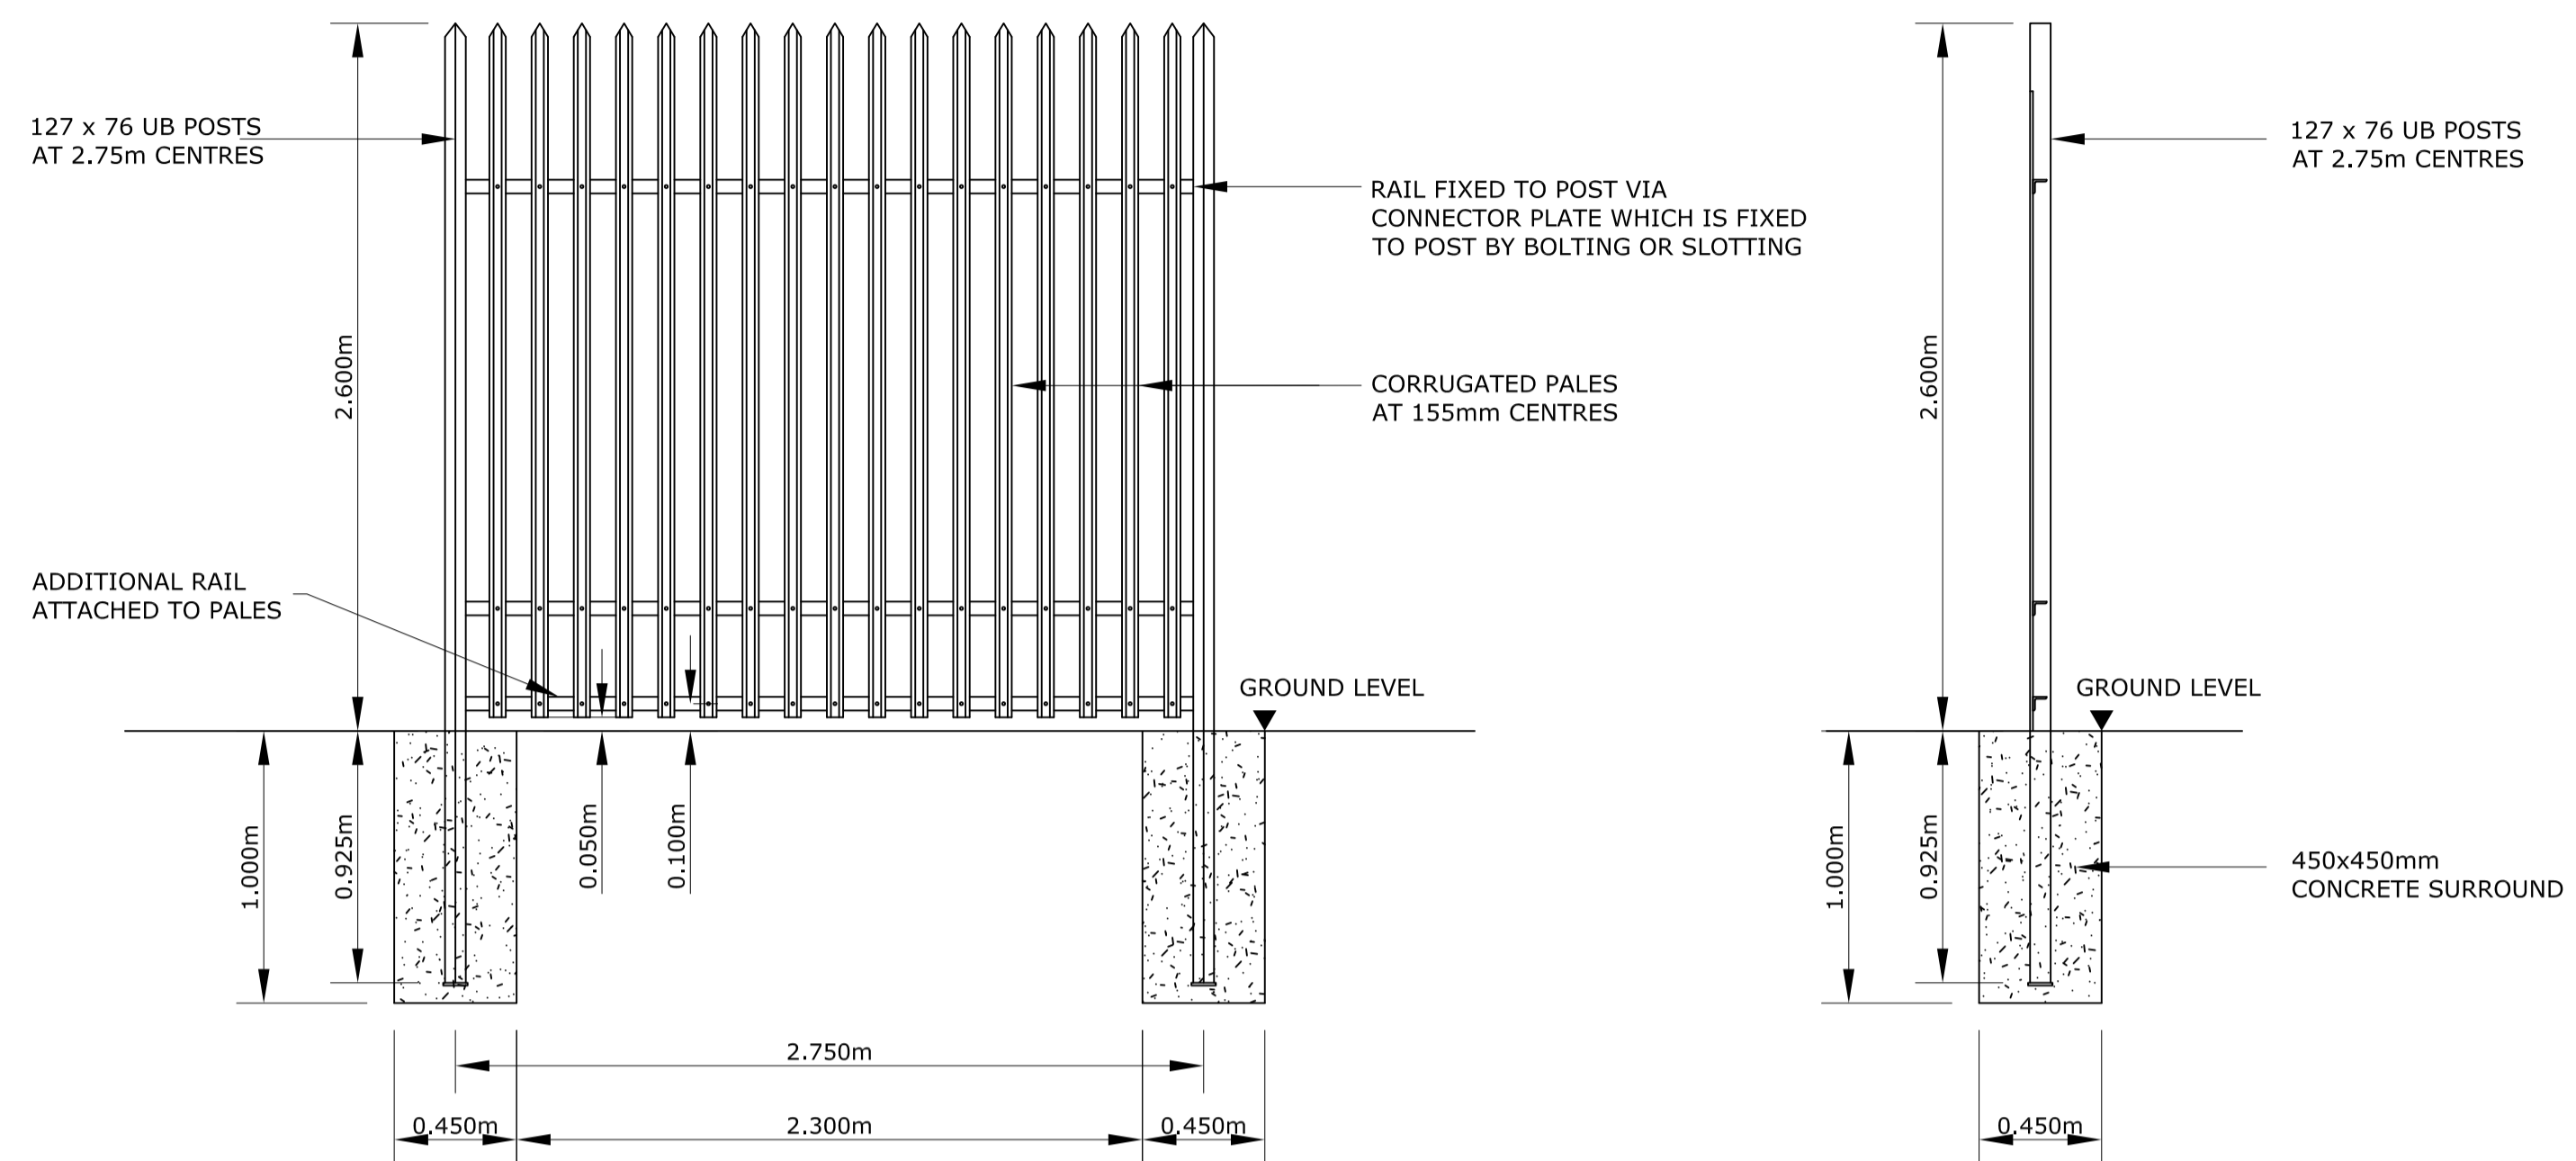


**DETAIL A
TYPICAL ARRANGEMENT OF STEEL PALISADE FENCE**
SCALE 1:25


- Legend:**
- Woodland Substation Planning Area
 - Existing Equipment
 - Proposed Equipment
 - Existing Fencing
 - Existing Fencing to be removed
 - Proposed New Fencing

- NOTES:**
- FIGURED DIMENSIONS ONLY TO BE TAKEN FROM THIS DRAWING.
 - ALL LEVELS SHOWN RELATE TO ORDNANCE SURVEY DATUM AT MALIN HEAD

Rev	Date	Description	By	Chkd.
A	Jan.'14	PLANNING ISSUE	MN	DG

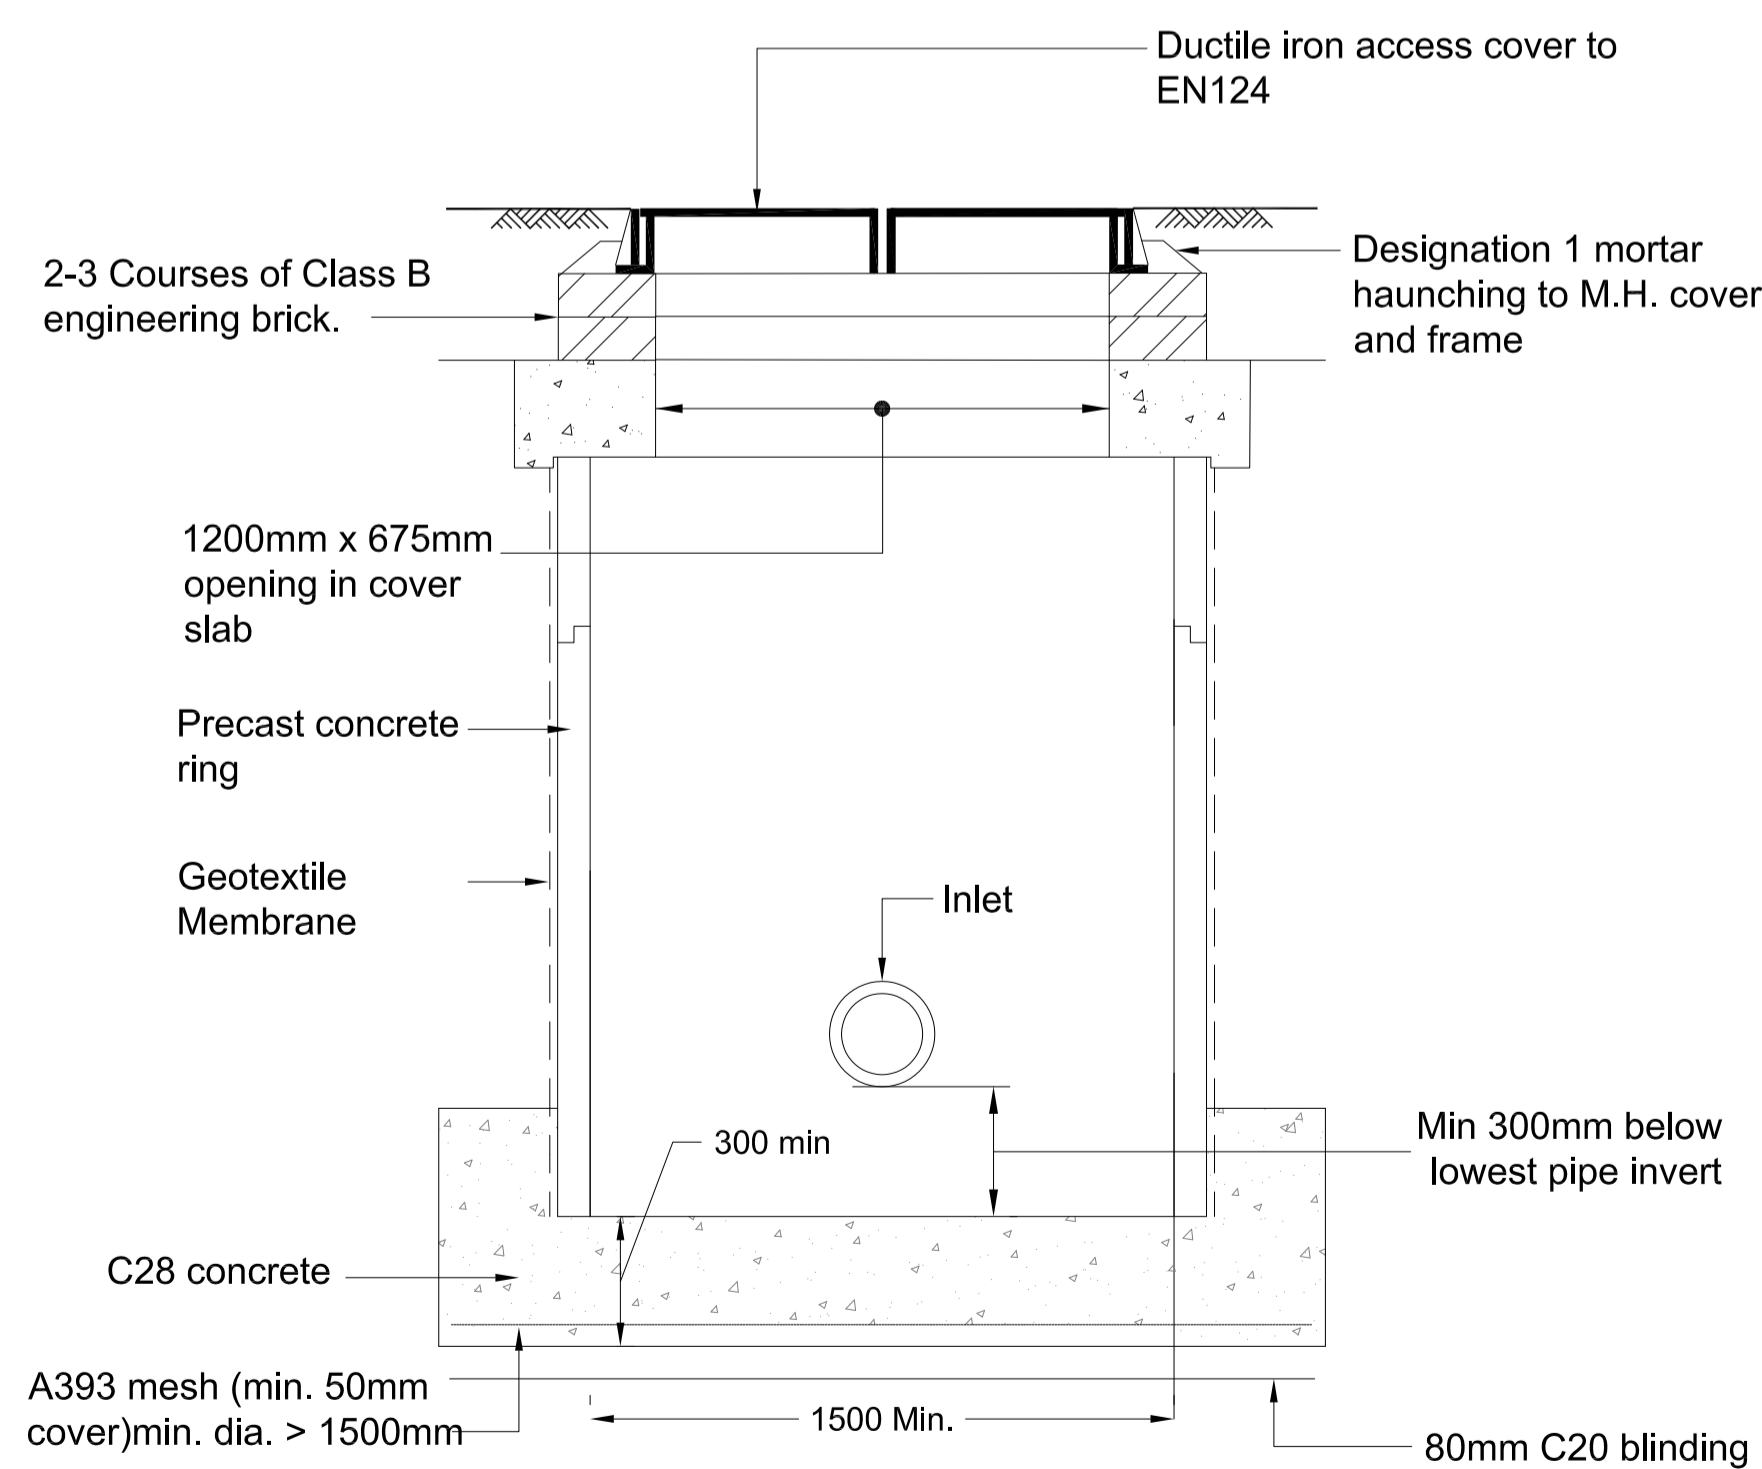

TYPICAL PRECAST MANHOLE DETAIL
SCALE 1:20

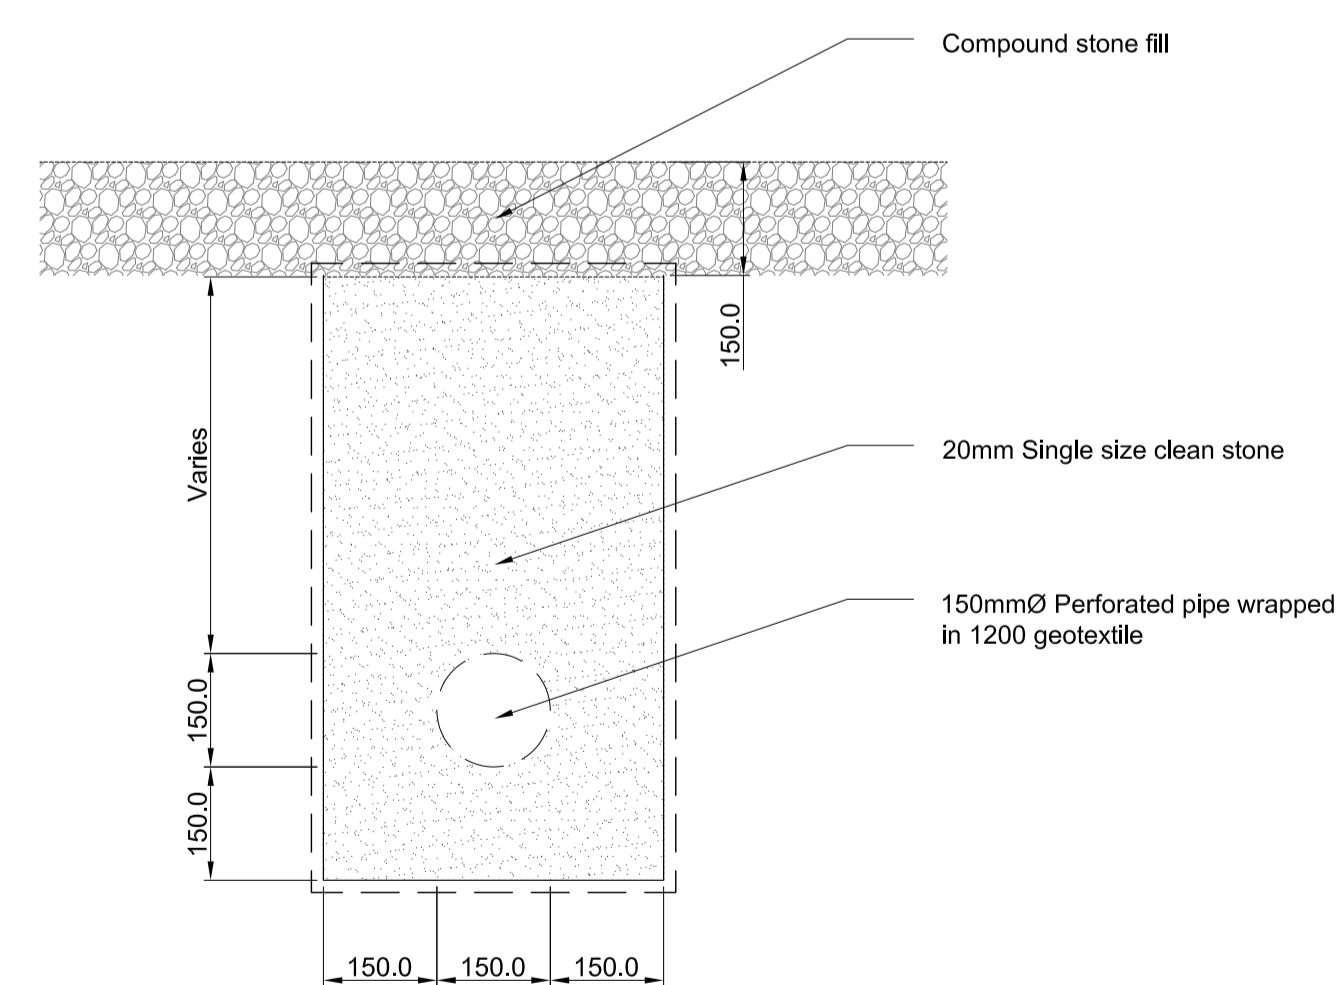

TYPICAL LAND DRAIN DETAIL
Scale 1:10

Note:
For drainage layout refer to Drawing No: MT-006-005

Client:

Project: **NORTH - SOUTH 400 KV INTERCONNECTION DEVELOPMENT**

Title: **MEATH STUDY AREA (MSA) WOODLAND 400 KV SUBSTATION TYPICAL DETAILS**

Scale @ A1: **AS SHOWN**

Prepared by: M. Nolan Checked: D. Grehan Date: January 2014

Project Director: D. Grehan

Planning Dwg. Ref: MT-006-006

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Drawing No.: **6244-2057** Revision: **A**